


HAYWOOD COUNTY ELECTION COMMISSION BUILDING RENOVATION





100% CONSTRUCTION DOCUMENTS AUGUST 23, 2024 PROJECT NUMBER 24262

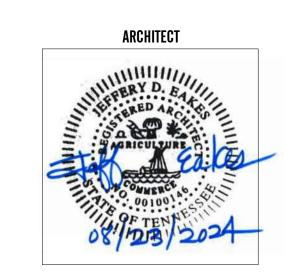

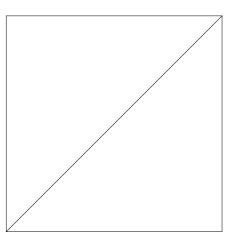


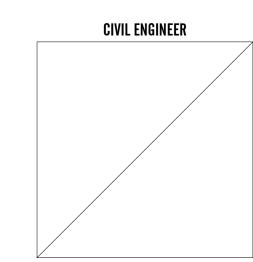

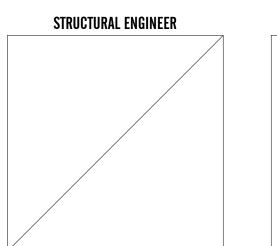

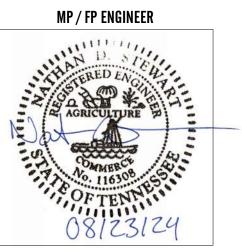


A2H, INC.

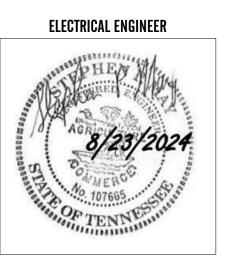

50 BOYD AVE.
BROWNSVILLE, TN 38012

3009 L

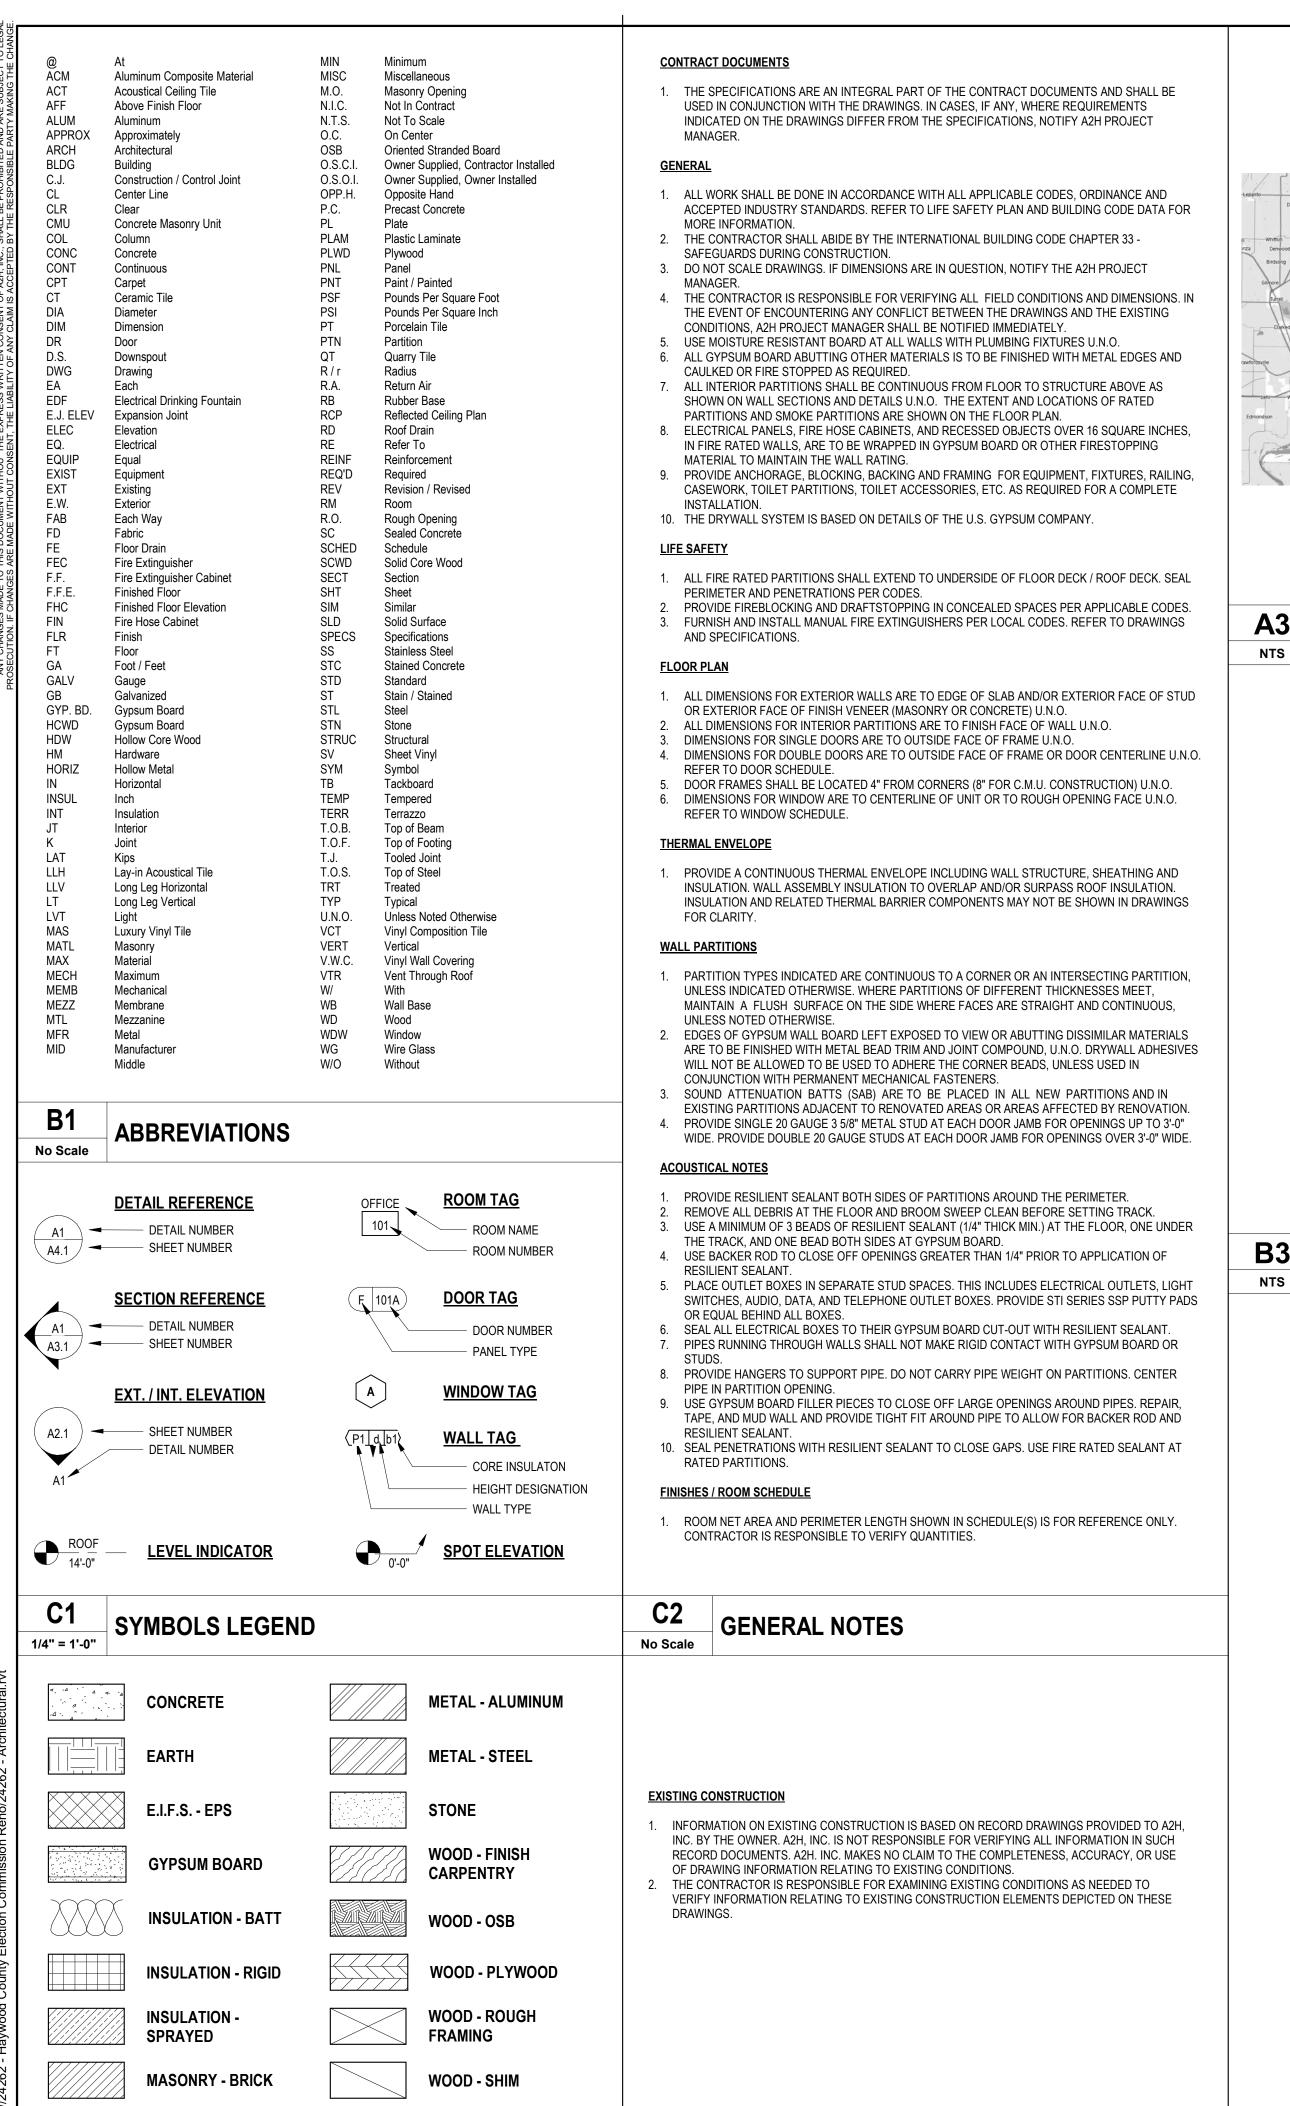


DISCLAIMER NOTES

No Scale

ARCHITECTURAL MATERIALS LEGEND

12" = 1'-0"

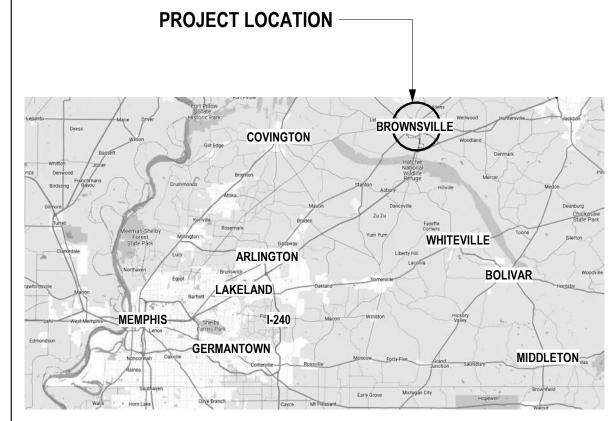





PROJECT LOCATION

B3 LOCATION MAP / VIEW



SHEET NUMBER	SHEET NAME	ISSUE DATE	CURRENT REVISION	REVISION Date
G0.0 G0.1	COVER SHEET PROJECT DATA AND NOTES	08/23/24 08/23/24		

ARCHITECTURAL

SHEET NUMBER	SHEET NAME	ISSUE DATE	CURRENT REVISION	REVISION DATE
A0.1	FLOOR PLAN - DEMOLITION	08/23/24		
A1.1	FLOOR PLAN	08/23/24		
A1.3	ENLARGED RESTROOM & ELEVATIONS	08/23/24		
A1.4	SITE DETAILS - RAMP	08/23/24		
A6.1	DOOR, WINDOW & INTERIOR DETAILS	08/23/24		
A7.1	FINISH PLAN & SCHEDULE	08/23/24		
A8.1	REFLECTED CEILING PLAN	08/23/24		

MECHANICAL

SHEET NUMBER	SHEET NAME	ISSUE DATE	CURRENT REVISION	REVISION DATE
M1.1 M2.1	HVAC FLOOR PLAN HVAC DETAILS	08/23/24 08/23/24		

PLUMBING

SHEET NUMBER	SHEET NAME	ISSUE DATE	CURRENT REVISION	REVISIO DATE
P1.1	PLUMBING FLOOR PLAN	08/23/24		
P2.1	PLUMBING FIXTURE SCHEDULE AND DETAILS	08/23/24		

ELECTRICAL

SHEET NUMBER	SHEET NAME	ISSUE DATE	CURRENT REVISION	REVISION DATE
50.0	ELECTRICAL LECEND AND MOTEO			
E0.0	ELECTRICAL LEGEND AND NOTES	08/23/24		
E1.0	ELECTRICAL - DEMOLITION - FLOOR PLAN	08/23/24		
Ξ1.1	LIGHTING - FIRST FLOOR PLAN	08/23/24		
2.1	POWER - FIRST FLOOR PLAN	08/23/24		
E7.0	ELECTRICAL SPECIFICATIONS	08/23/24		



A2H, INC.
3009 DAVIES PLANTATION ROAD
LAKELAND, TN 38002
P. 901.372.0404
WWW.A2H.COM



AYWOOD COUNTY

ELECTION
COMMISSION
BUILDING
RENOVATION

50 BOYD AVE. Brownsville, TN 38012

100% CONSTRUCTION DOCUMENTS


REVISIONS

PROJECT NO.	DATE
24262	AUGUST 23, 2024
DRAWN	CHECKED
Author	Checker

PROJECT DATA AND NOTES


G0.1

D5 SHEET INDEX

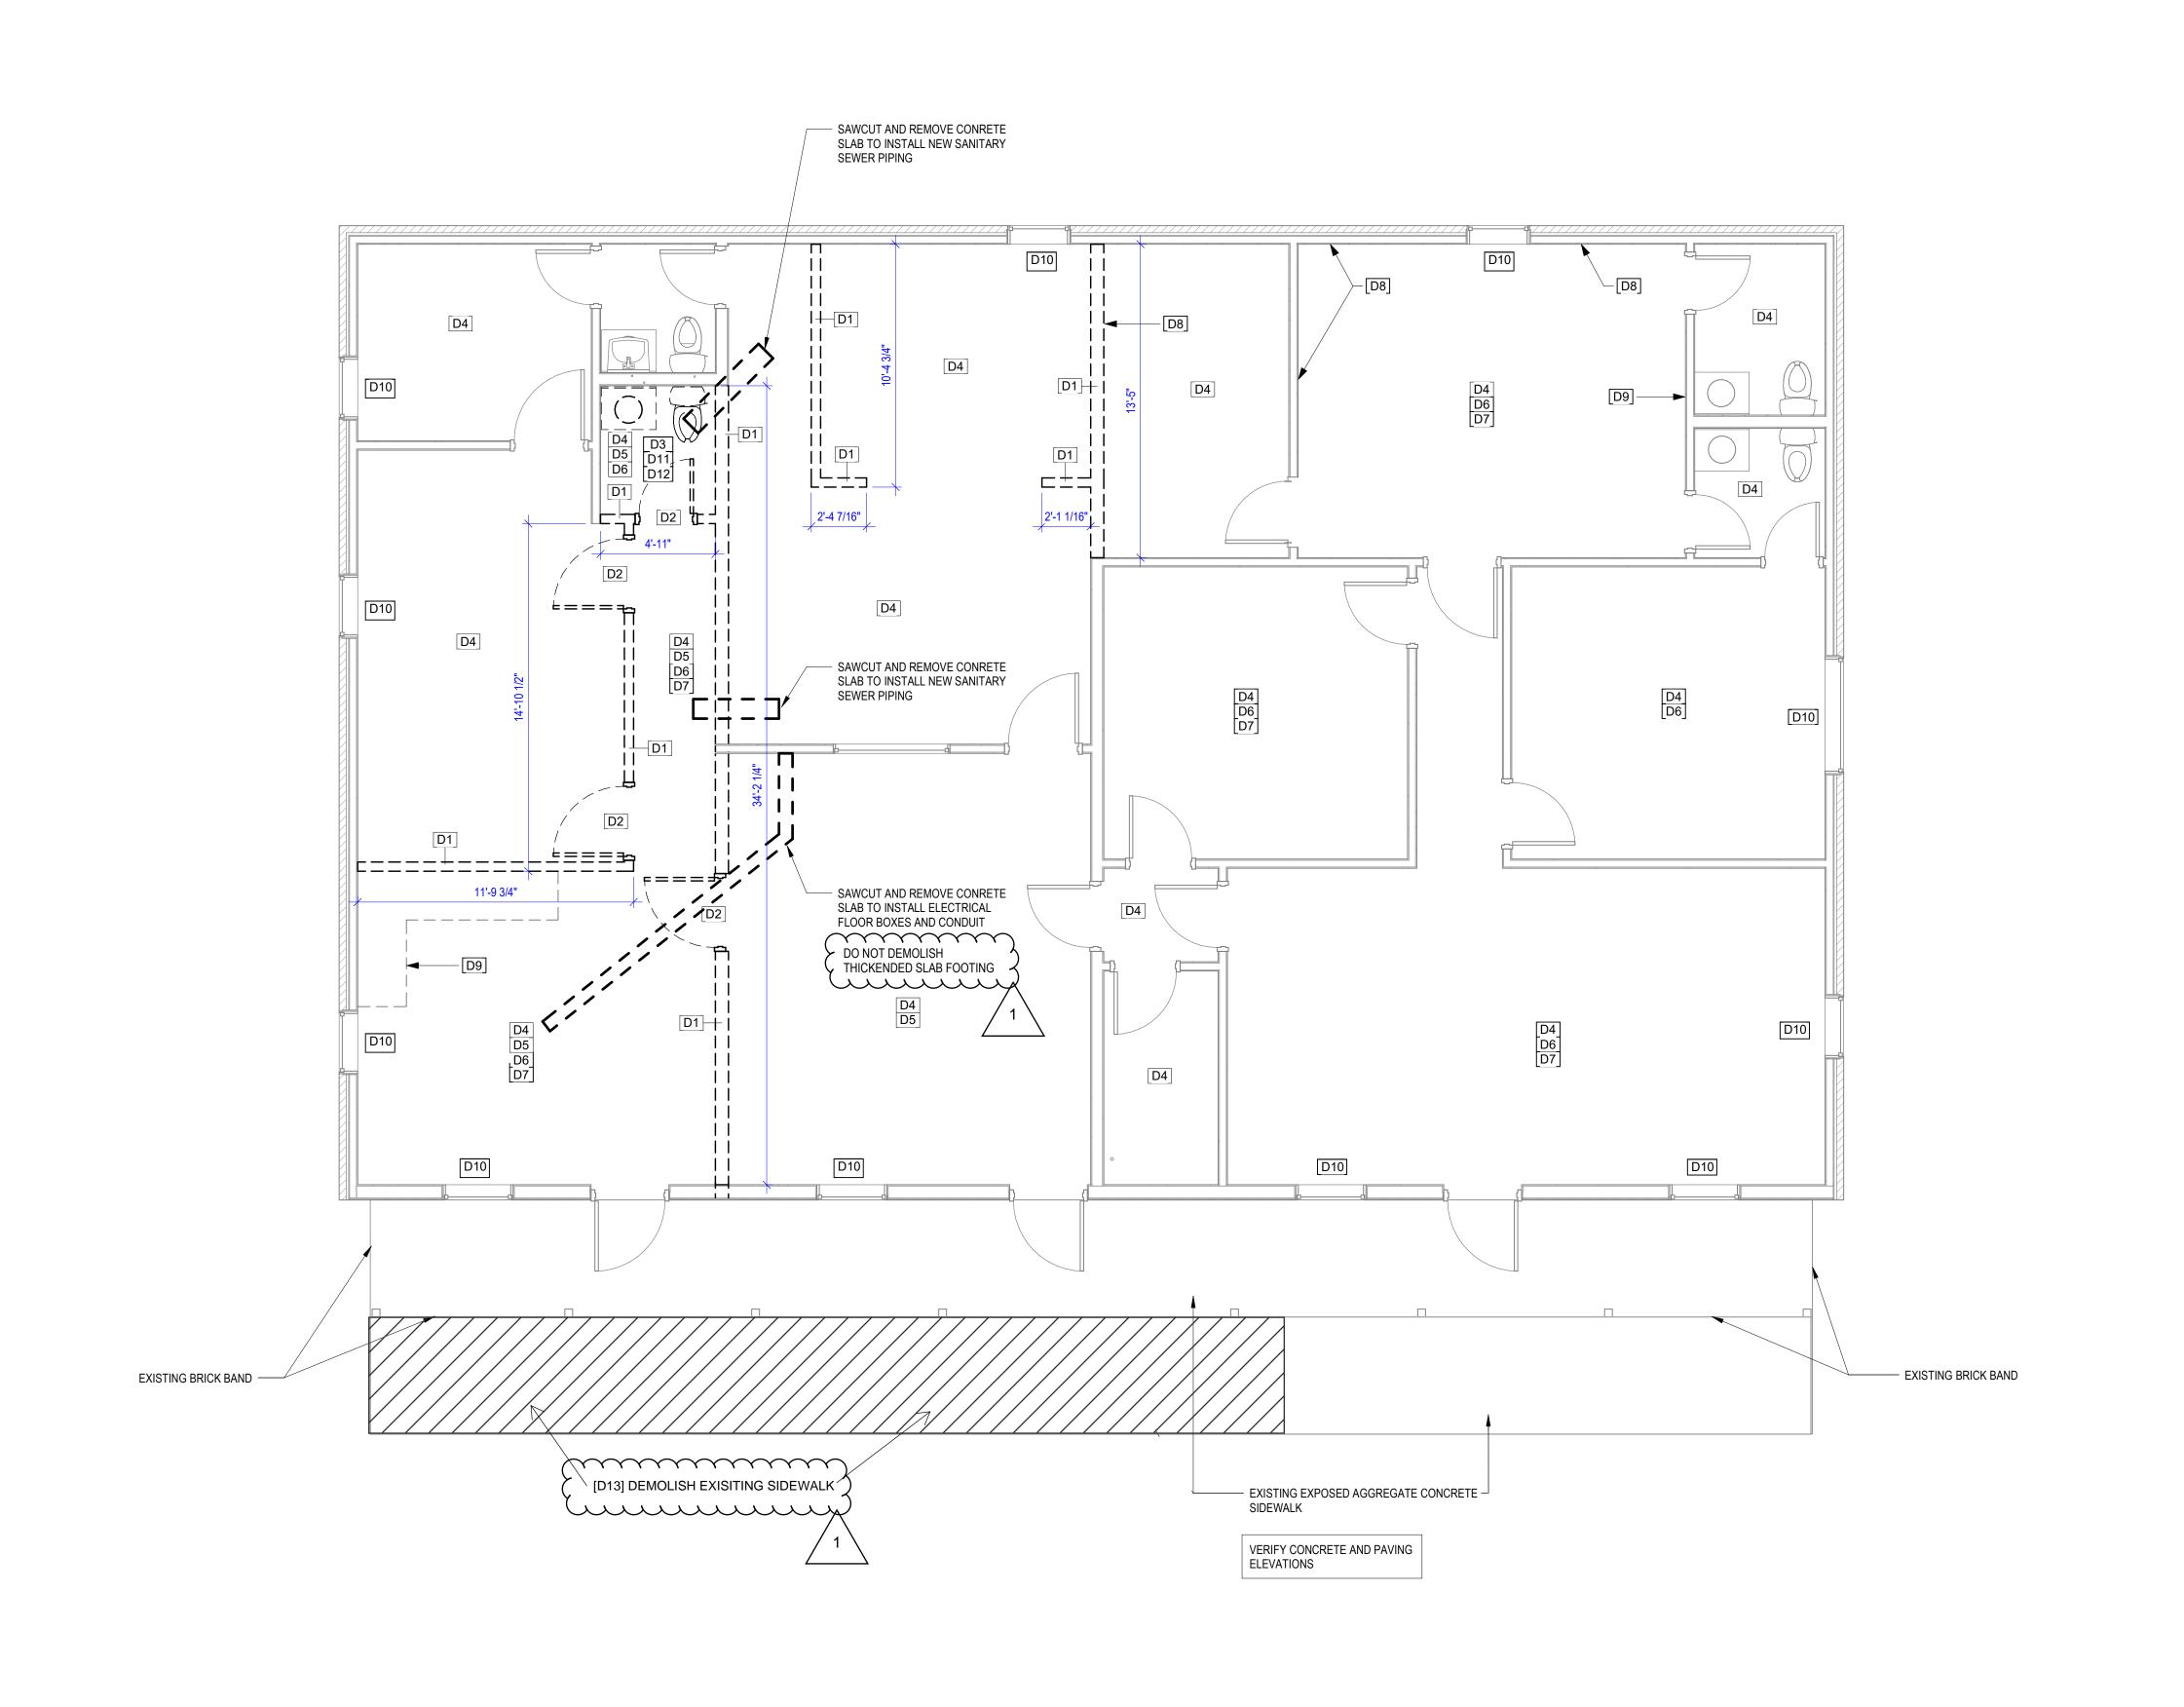

FLOOR PLAN - DEMOLITION

1/4" = 1'-0"

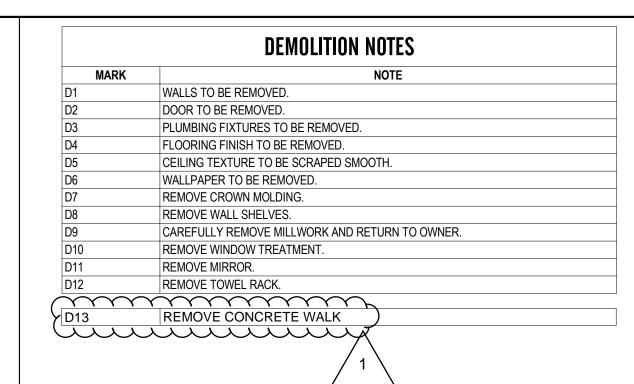



A2H, INC.
3009 DAVIES PLANTATION ROAD
LAKELAND, TN 38002
P. 901.372.0404
WWW.A2H.COM



HAYWOOD COUNTY

ELECTION COMMISSION BUILDING RENOVATION

50 BOYD AVE. Brownsville, TN 38012

100% CONSTRUCTION DOCUMENTS

REVISIONS

#1: NOVEMBER 18, 2024

DDUIEGE NU	DATE

PROJECT NO. DATE
24262 AUGUST 23, 2024

DRAWN CHECKED
HA JE

FLOOR PLAN -DEMOLITION

A O 4

D5 No Scale

DEMOLITION NOTES

WALL LEGEND

DEMOLITION GENERAL NOTES

LEGALLY DISPOSED OF.

LOCATION WITH OWNER.

TO DEMOLITION ACTIVITY.

DEMO WALL

EXISTING WALL

1. CONTRACTOR SHALL BE RESPONSIBLE FOR DEMOLITION DEBRIS REMOVAL AND SHALL CONFORM TO ALL APPLICABLE REGULATORY REQUIREMENTS. ALL DEBRIS SHALL BE PROMPTLY AND

2. CONTRACTOR SHALL BE RESPONSIBLE FOR PROVIDING TRASH CONTAINERS. COORDINATE

5. CONTRACTOR TO PROTECT ALL AREAS AND ITEMS TO REMAIN WHICH ARE IN CLOSE PROXIMITY

INSTALL DUST BARRIERS IN ALL AREAS TO CONTROL DUST MIGRATION. CLEAN AND VACUUM ALL

8. EXISTING FLOORING TO BE REMOVED IN RENOVATED AREAS, REFER TO FLOOR FINISH PLAN FOR NEW FLOORING LOCATIONS AND DEMO EXISTING AS NEEDED. CLEAN AND PREP SUBFLOOR OR

9. REMOVE EXISTING WOOD DOORS, HARDWARE, AND FRAMES AS INDICATED AND SALVAGE AS

10. PATCH AND REPAIR EXISTING WALLS, CEILINGS AND FLOORS, WITH MATERIALS TO MATCH EXISTING, AS REQUIRED TO RECEIVE NEW FINISHES AND TO ACCOMMODATE RENOVATIONS.

12. RELOCATE EXISTING DATA AND ELECTRICAL AS REQUIRED TO ACCOMMODATE RENOVATIONS.

13. SEE MECHANICAL, PLUMBING AND ELECTRICAL SHEETS FOR ADDITIONAL DEMOLITION NOTES.

6. PROTECT ALL CARPET, FURNISHINGS, AND FINISHES FROM DAMAGE DURING DEMOLITION.

3. CONTRACTOR PERFORMING THE WORK SHALL BE RESPONSIBLE FOR REQUIRED UTILITY CONNECTION, SEQUENCE OF WORK, TEMPORARY LOADING, TEMPORARY SHORING, DUST

4. CONTACT ARCHITECT IMMEDIATELY IF LIMITS OF DEMOLITION BECOME UNCLEAR.

7. EXISTING WALLS DENOTED BY A DASHED LINE ON PLAN TO BE REMOVED.

11. REMOVE EXISTING TOILET ACCESSORIES AND SAVE FOR REINSTALLATION.

SLAB FOR NEW FLOORING AS NOTED IN ROOM FINISH SCHEDULE.


ABATEMENT, AND ALL STAGING AND STORAGE AREAS.

AREAS THOROUGHLY AFTER COMPLETION.

REQUIRED FOR REUSE ON THE PROJECT.

REFER TO ELECTRICAL SHEETS.

NEW WALL

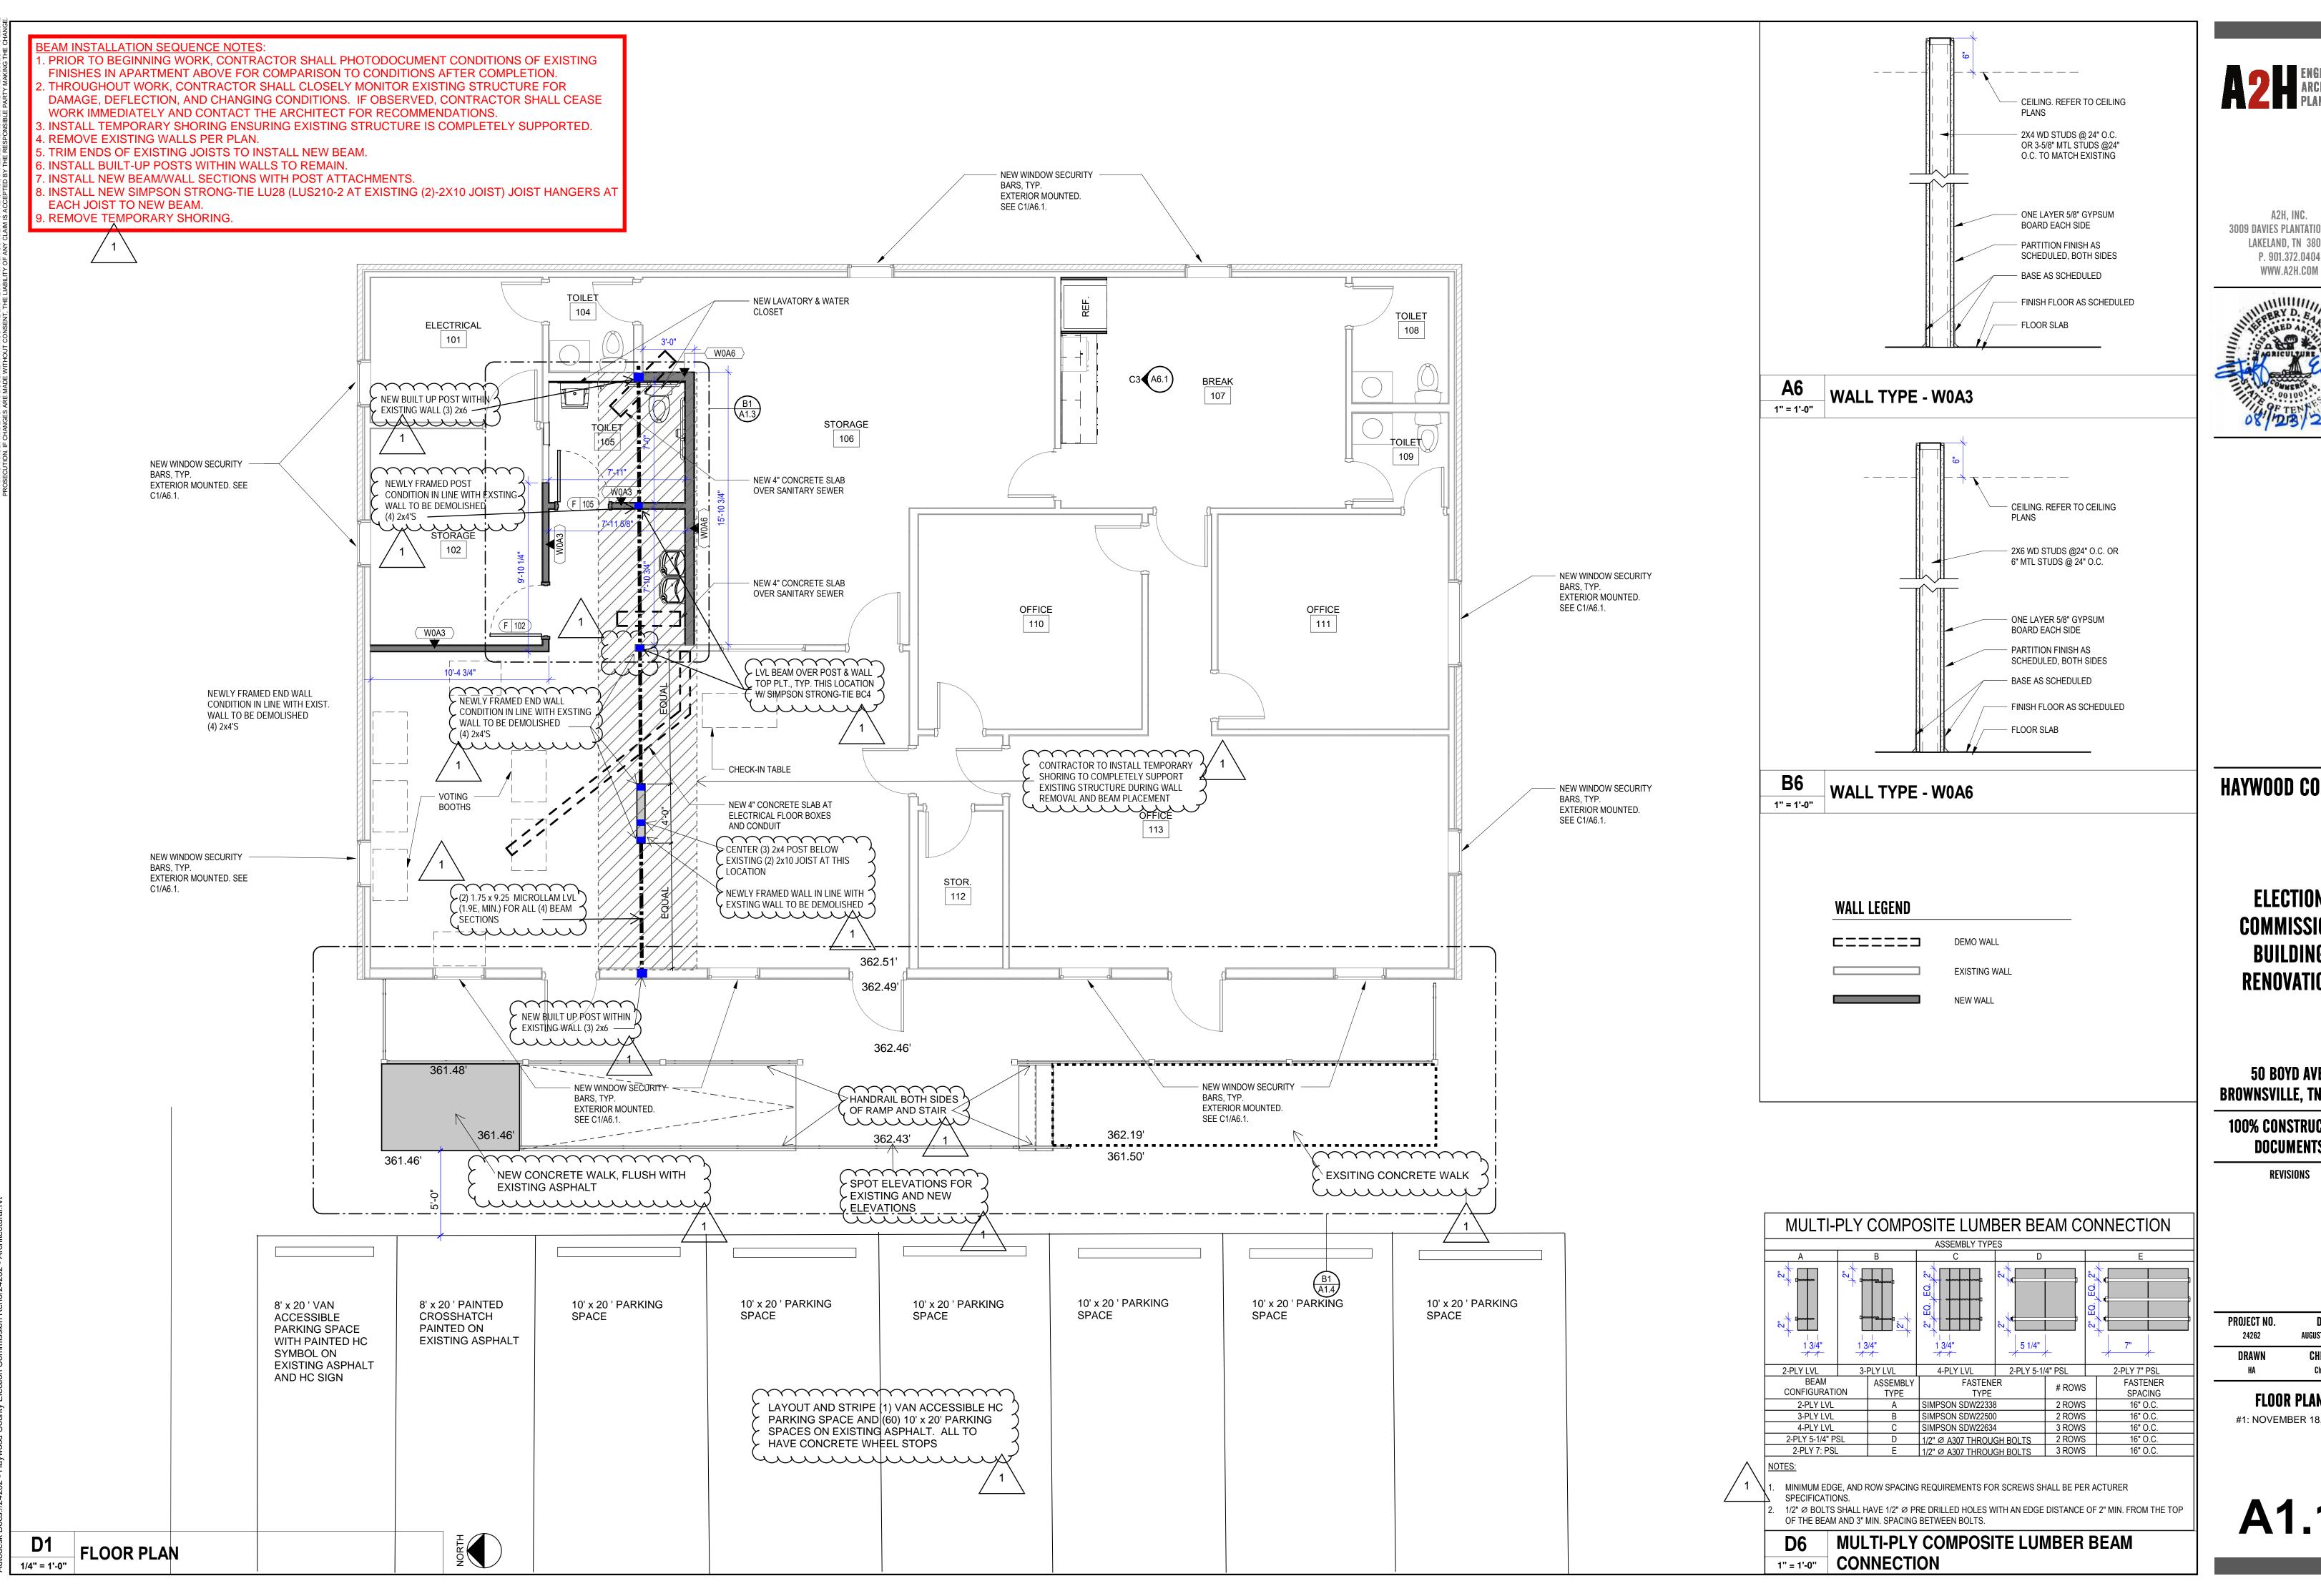

A2H, INC. **3009 DAVIES PLANTATION ROAD** LAKELAND, TN 38002 P. 901.372.0404



HAYWOOD COUNTY


ELECTION COMMISSION BUILDING **RENOVATION**

50 BOYD AVE. **BROWNSVILLE, TN 38012**

100% CONSTRUCTION DOCUMENTS

DATE AUGUST 23, 2024 CHECKED


FLOOR PLAN #1: NOVEMBER 18, 2024

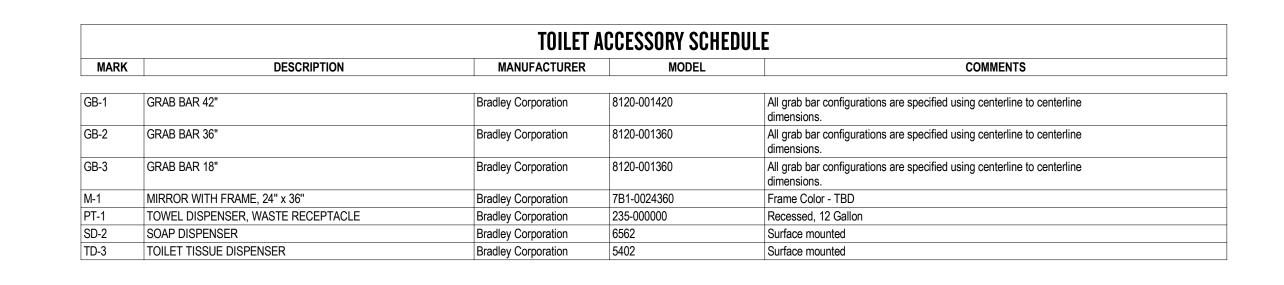




A2H, INC. 3009 davies plantation r Lakeland, tn 38002 P. 901.372.0404 www.a2h.com




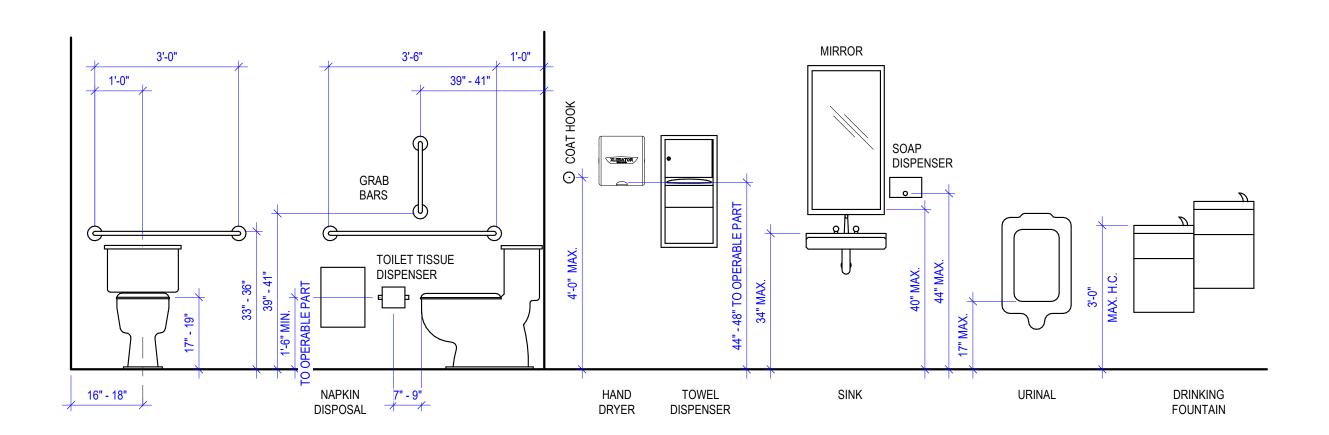

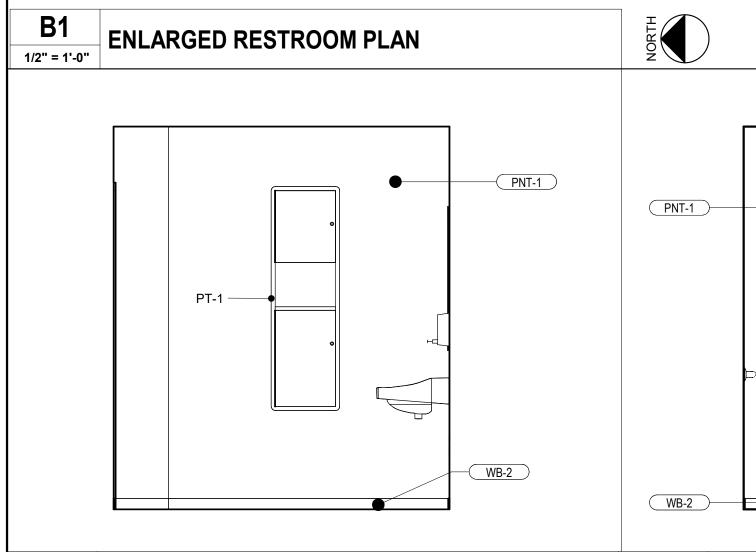



TOILET 105 - NORTH ELEVATION

C1

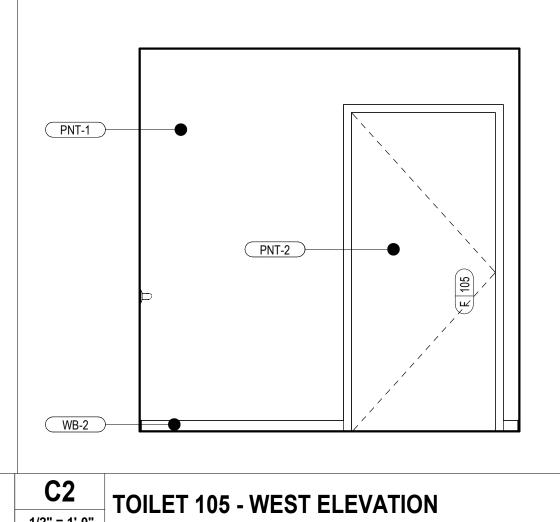

— GB-1

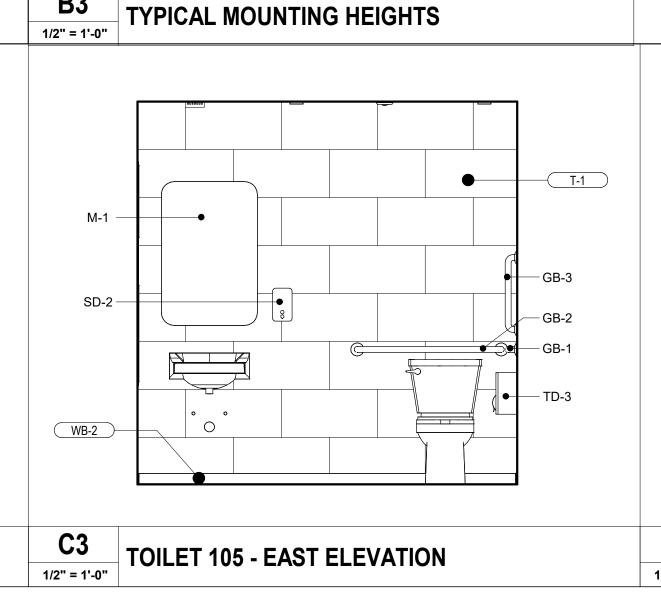

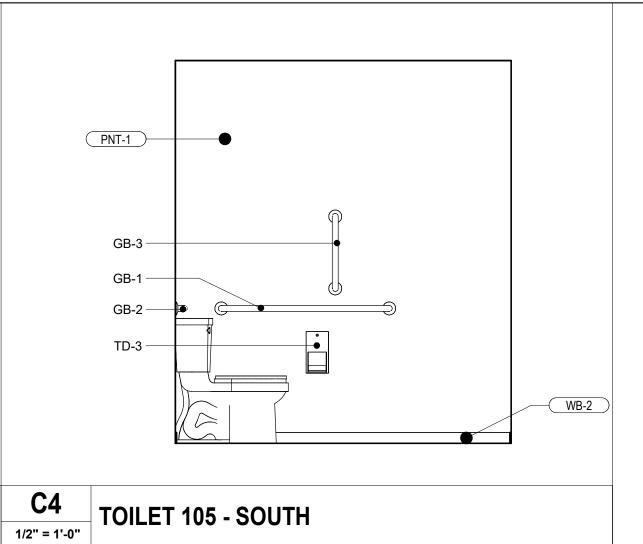

HAYWOOD COUNTY

ELECTION
COMMISSION
BUILDING
RENOVATION

50 BOYD AVE. BROWNSVILLE, TN 38012


100% CONSTRUCTION DOCUMENTS

REVISIONS

PROJECT NO.	DATE
24262	August 23, 2024
DRAWN	CHECKED
Author	Checker


ENLARGED RESTROOM & ELEVATIONS

A1.3

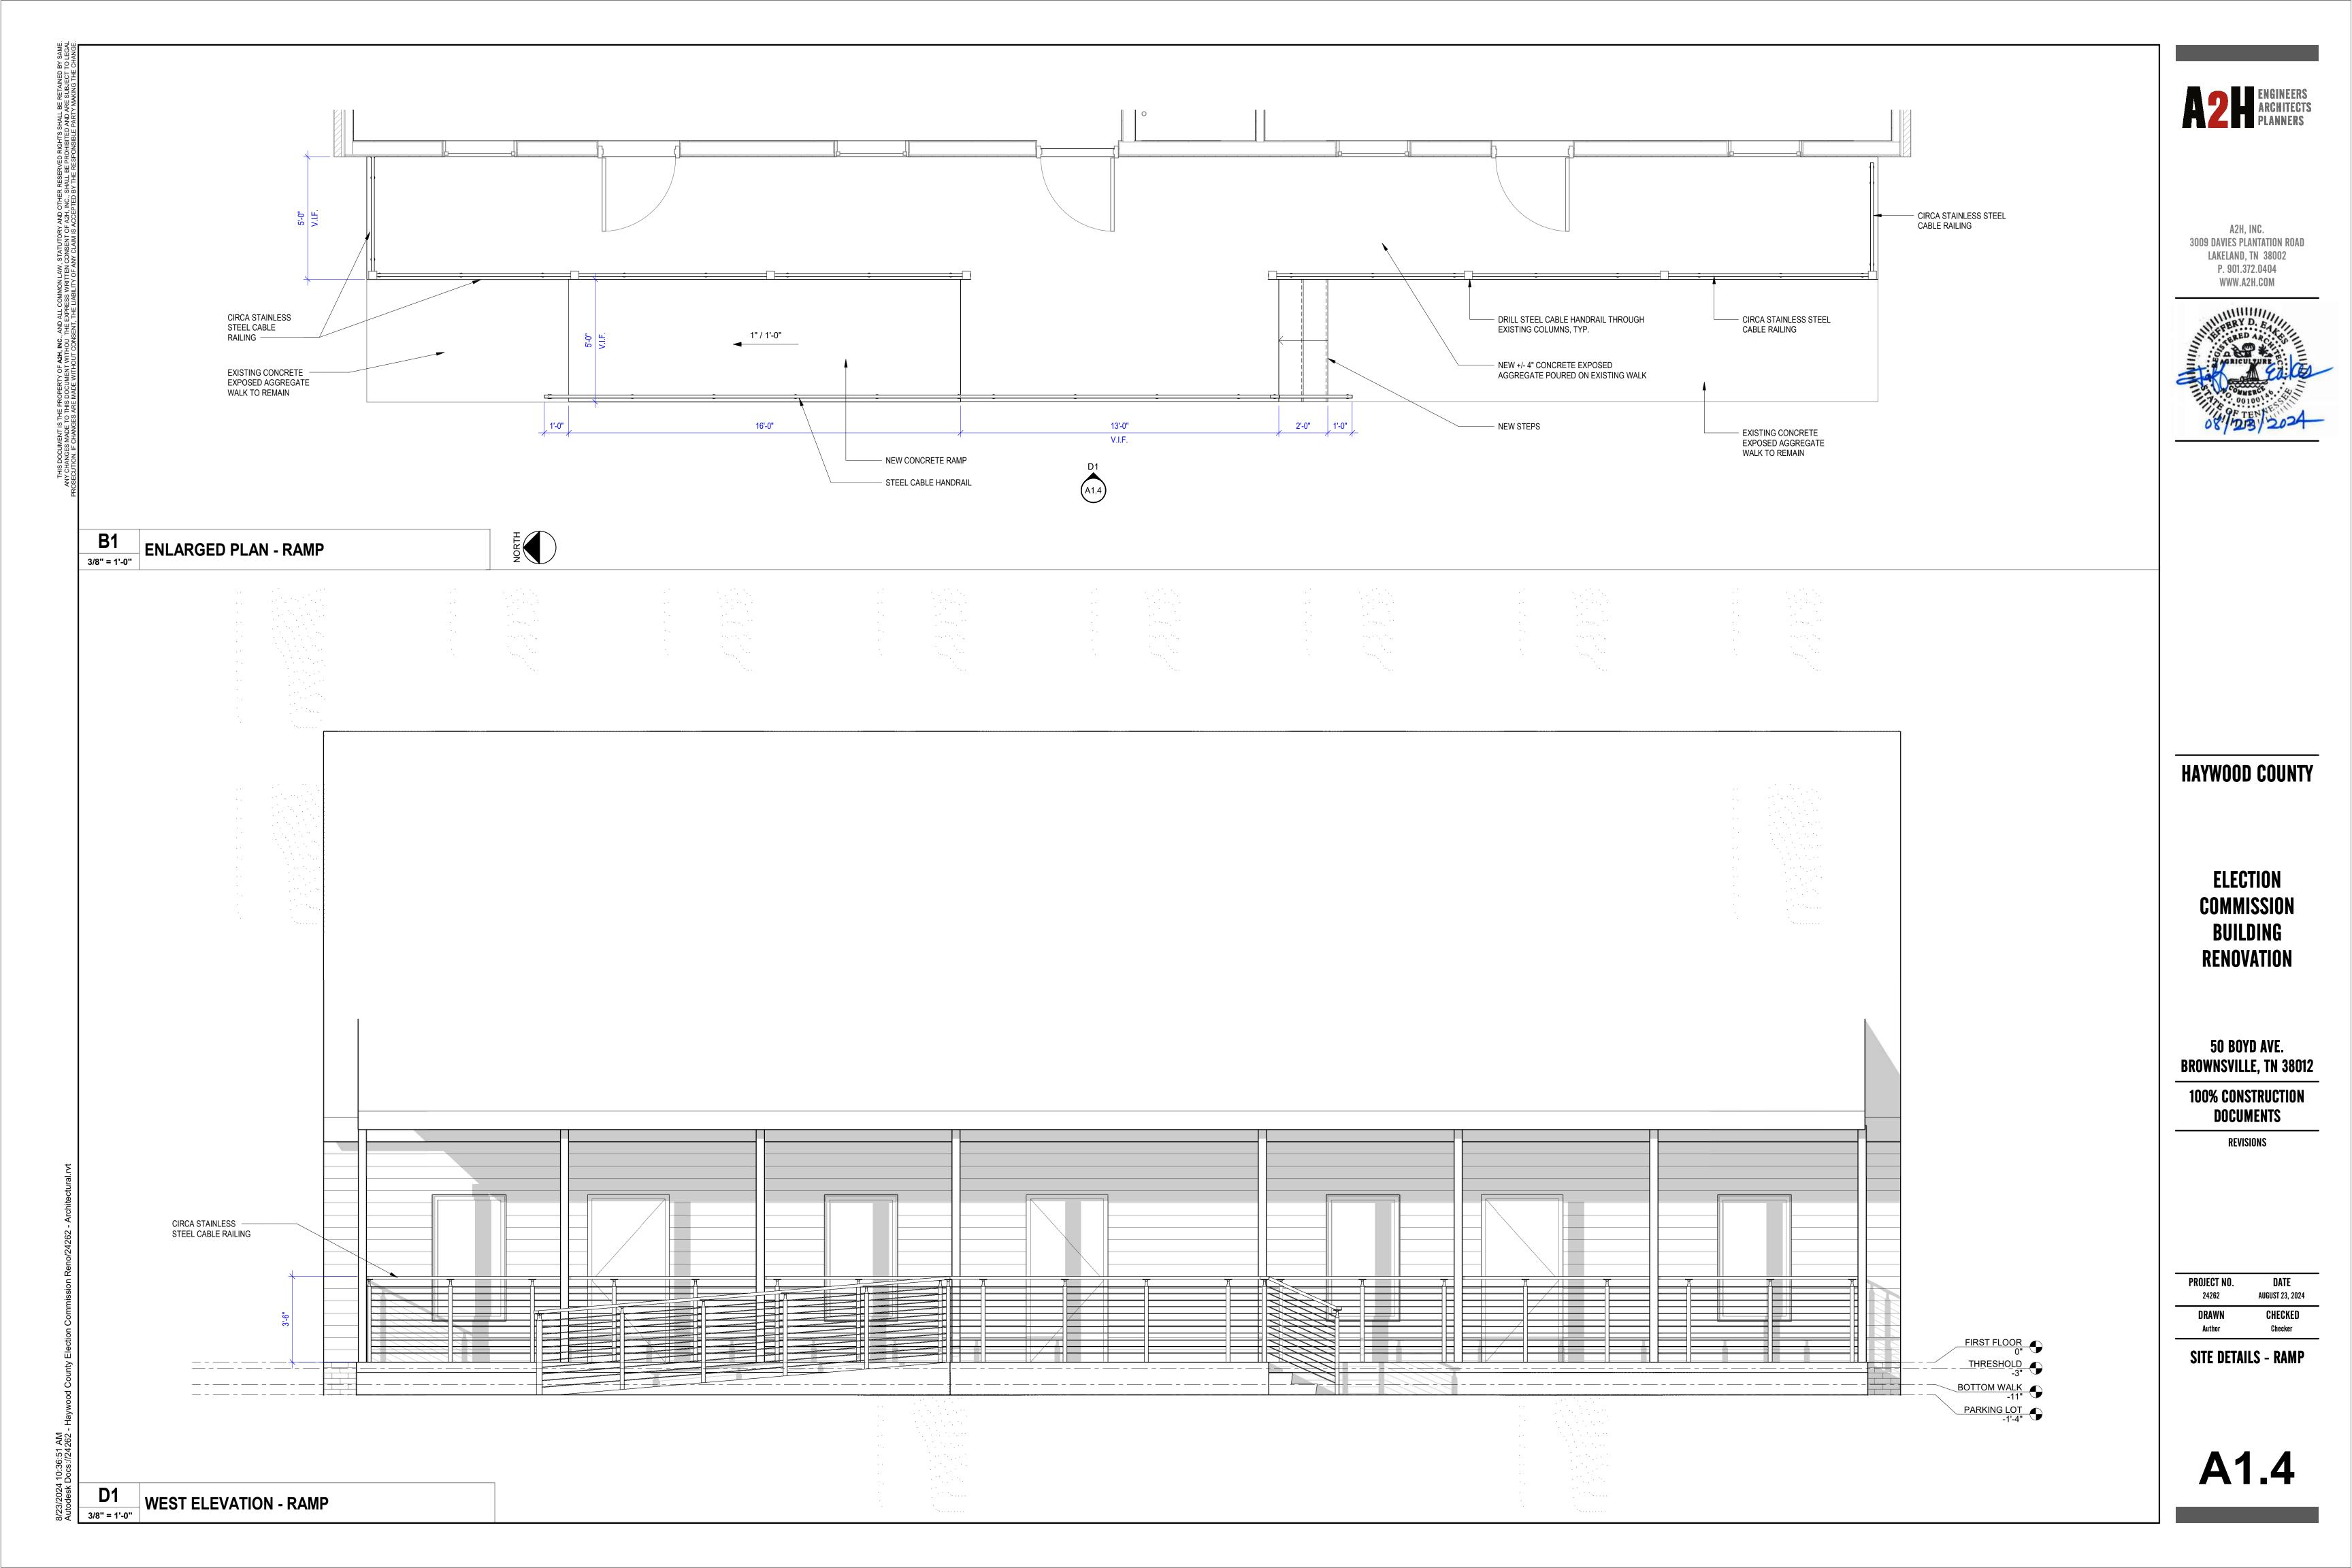

	DOOR SCHEDULE																	
				DOOR						FRAME			HARD	WARE				
												SMOKE	WEATHER	ACCESS	HARDWARE	FIRE		
MARK	WIDTH	HEIGHT	THICK	MATERIAL	FINISH	TYPE	GLAZING	MATERIAL	FINISH	WRAP FRAME	FRAME DEPTH	GASKET	STRIPPING	CONTROL	SET NO.	RATING	COMMENTS	Phase Created
102	3'-0"	6'-8"	1 3/4"	WD	PNT-2	F	NONE	WD	PNT-2	No	5 3/4"	No	No					New Construction
105	3'-0"	6'-8"	1 3/4"	WD	PNT-2	F	NONE	WD	PNT-2	No	5 3/4"	No	No					New Construction

A2H, INC. LAKELAND, TN 38002 P. 901.372.0404

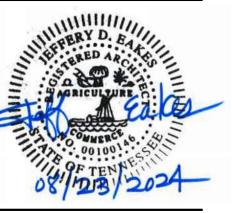

WWW.A2H.COM



HAYWOOD COUNTY

- 3/4" PLYWOOD W/ PLAM

- DOOR W/ PLAM

— 1 1/2" COUNTERTOP, FINISH AS SPECIFIED

- 3/4" PLYWOOD W/ PLAM

— DOOR W/ PLAM

CONT. WALL BASE

--- WOOD BLOCKING

DRAWER W/ PLAM

1X4 WOOD

BLOCKING

BACKING

1X4 WOOD BLOCKING

4" BACKSPLASH. FINISH AS

SPECIFIED

1 X4 WOOD -BLOCKING

METAL SLIDE

1/4" PLYWOOD

3/4" PLYWOOD ADJ. SHELF W/ PLAM

BACKING

METAL -STANDARDS

1 X4 WOOD -BLOCKING

C5

WOOD BLOCKING

1/4" PLYWOOD

3/4" PLYWOOD ADJ. SHELF W/ PLAM

METAL STANDARDS -

1'-1 1/2"

2'-0"

CABINET - DRAWER W/ UPPERS - ADA

ELECTION COMMISSION **BUILDING** RENOVATION

50 BOYD AVE. **BROWNSVILLE, TN 38012**

100% CONSTRUCTION DOCUMENTS

REVISIONS

DATE AUGUST 23, 2024 CHECKED

DOOR, WINDOW & INTERIOR DETAILS

DOOR GENERAL NOTES:

A. PAINT ALL EXISTING INTERIOR DOORS PNT-2.

WINDOWS AND GLAZING NOTES:

A. CONTRACTOR IS RESPONSIBLE FOR VERIFYING QUANTITIES AND SIZES OF WINDOWS. NOTIFY THE ARCHITECT OF ANY DISCREPANCIES.

FLUSH 6-PANEL

DOOR SCHEDULE & LEGEND N.T.S.

DOOR SCHEDULE LEGEND

STAIN


SOLID CORE WOOD


PLASTIC LAMINATE

<u>MATERIAL</u>

SCW

PNT-* ST-*

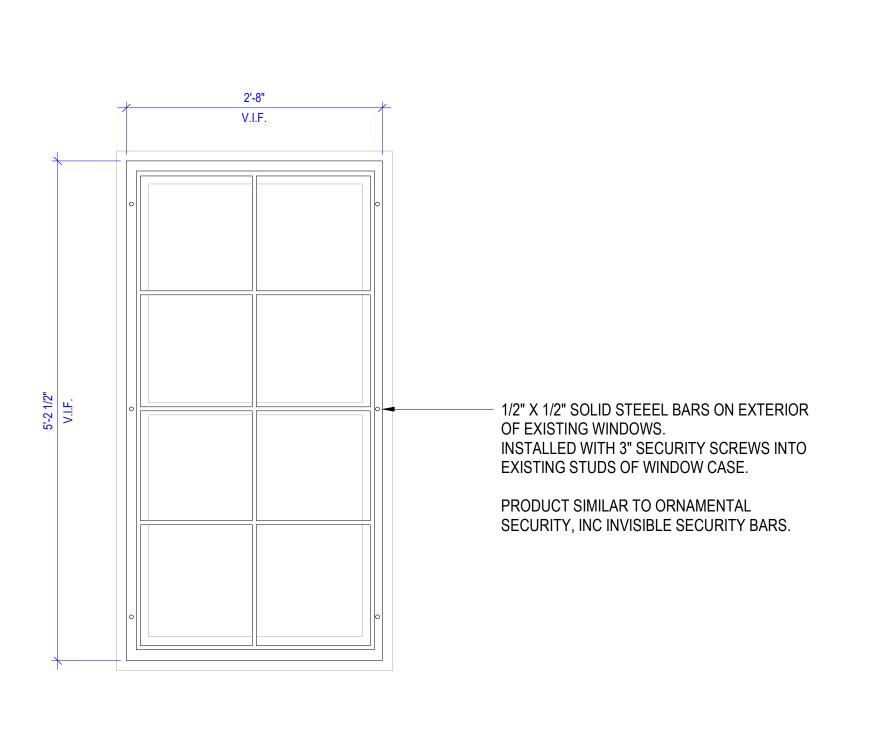


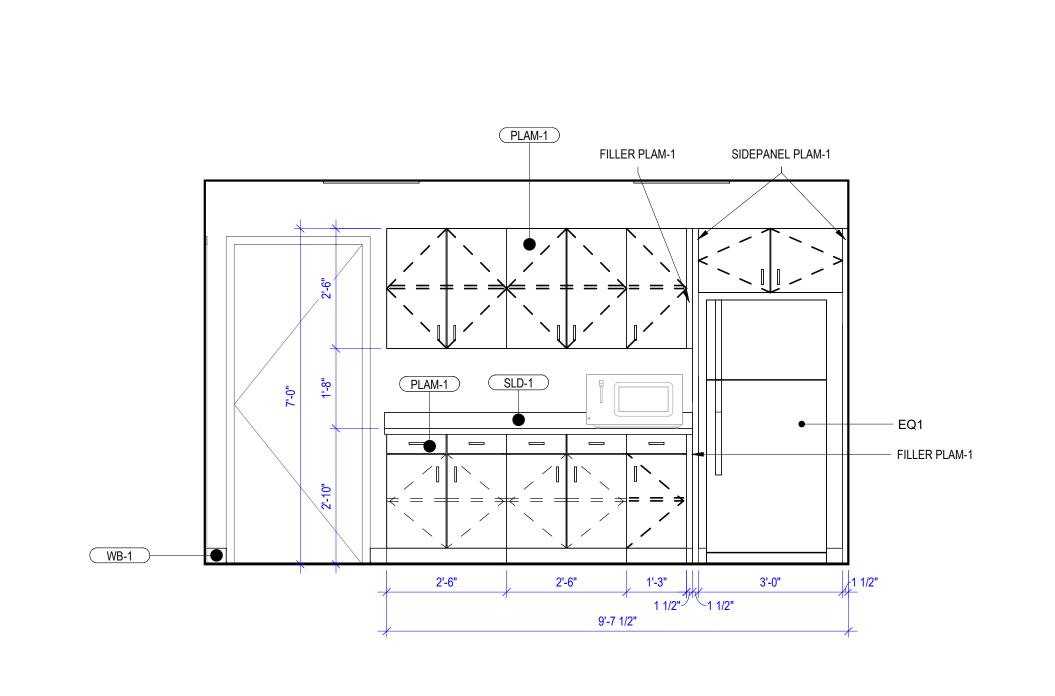

C3

BREAK 107 - NORTH ELEVATION

C1 TYP. WINDOW SECURITY BARS

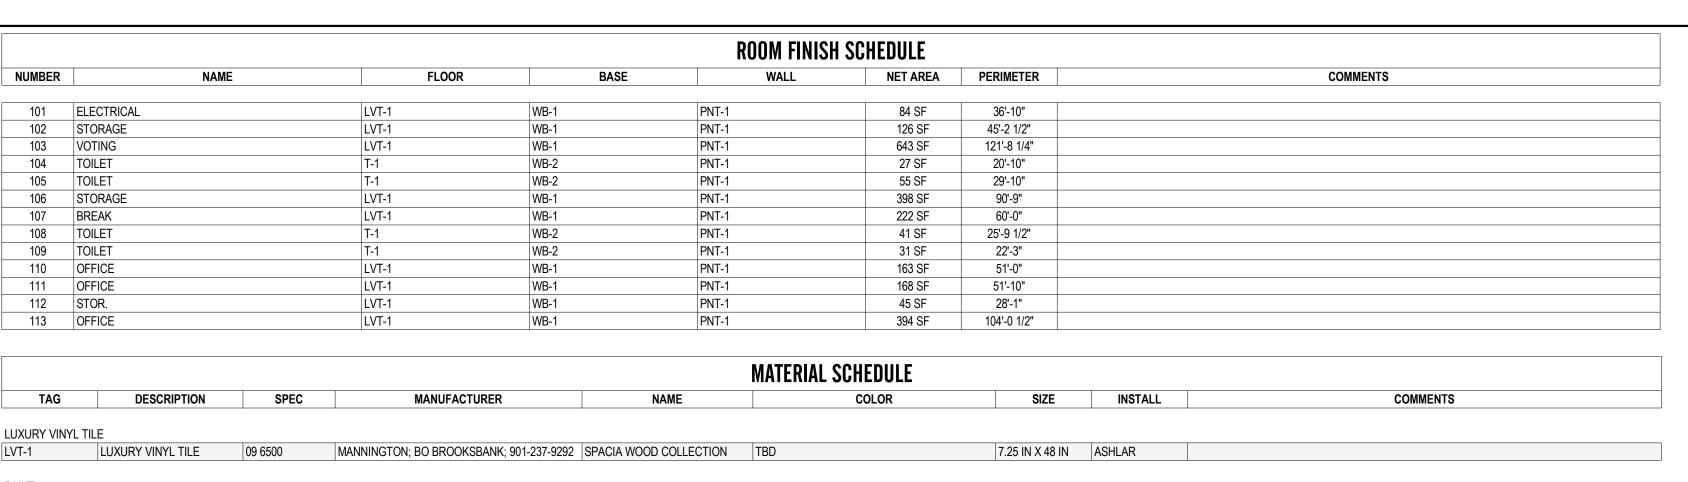

MATERIAL SCHEDULE										
TAG	DESCRIPTION	SPEC	MANUFACTURER	NAME	COLOR	SIZE	INSTALL	COMMENTS		
LUXURY VINYL	TILE									
LVT-1	LUXURY VINYL TILE	09 6500	MANNINGTON; BO BROOKSBANK; 901-237-9292	SPACIA WOOD COLLECTION	TBD	7.25 IN X 48 IN	ASHLAR			
PAINT										
PNT-1	INTERIOR PAINT	09 9000	SHERWIN WILLIAMS		TBD					
PNT-2	INTERIOR PAINT	09 9000	SHERWIN WILLIAMS		TBD			ALL INTERIOR DOORS AND DOORS FRAMES TO BE PAINTED		
PLASTIC LAMIN	IATE									
PLAM-1	PLASTIC LAMINATE	06 4100	FORMICA; CYNDI G. SULLIVAN; 662-312-8503		TBD					
SOLID SURFAC										
SLD-1	SOLID SURFACE	12 3600	DURASEIN; JENNIFER WINSTEAD; 901-568-2570	TIMELESS	TBD			1/2" THICK; HALF BULLNOSE EDGE; ROUNDED CORNERS		
TILE										
T-1	PORCELAIN TILE	09 3000	MILE STONE; JENNIFER WINSTEAD; 901-568-2570	AREA 51	STEEL	12" x 24"	RUNNING BOND	3/16" GROUT JOINT: INSTALL 1/3 OFFSET; LATICRETE SPECTRALOCK PRO PREMIUM GROU' COLOR XXX		
WB-2	PORCELAIN TILE WALL BASE	09 3000	MILE STONE; JENNIFER WINSTEAD; 901-568-2570	AREA 51	STEEL	3" X 12"		USE WITH TOE		
WALL BASE										
WB-1	WALL BASE	09 6500	TARKETT; KIM FULTON; 615-393-4054	TYPE TP (THERMOPLASTIC RUBBER)	TBD			USE WITH TOE		
WINDOW SHAD	E									
WS-01	MANUAL WINDOW SHADES	12 2400	MECHOSHADE; CHERIE SIMMONS: 770-519-0570	MECHO MANUAL SHADE SYSTEM	ECOVEIL SCREENS; 1350 SERIES; 5% OPEN; 1369 SILVER BIRCH			REFER TO FLOOR PLAN AND ELEVATIONS FOR SIZE		

		EQUIPN	MENT SCHEDULE	
TAG	MANUFACTURER MODEL		DESCRIPTION	COMMENTS
EQ1	FRIGIDAIRE FFTR1821TW	BREAK ROOM REFRIGERATOR, ITEM#	‡ 852886 - WHITE, 30"W X 29 7/8"D X 66 1/8"H	
SCHLUTER DILEX-AHK TRANSITION — CERAMIC TILE — CONCRETE SLAB —		CERAMIC TILE BASI OR WALL TILE	CONCRETE SLAB	SCHLU RENO- TRANS RESILI FLOOF
A5 _T	ILE FLOOR TO TILE WA	ΔΙΙ DETΔΙΙ ₋ ΔΗΚ	A6 THE TO RESH	LIENT FLR TRANSITION

FINISH ABBREVIATIONS

ALL GWB SURFACES TO BE PNT-1 UNLESS OTHERWISE ACT - ACOUSTIC CEILING TILE AWC - ACOUSTIC WALL COVERING CG - CORNER GUARD CLG - CEILING GWB COLOR CPT - CARPET EPNT - EPOXY PAINT EPX - EPOXY FLOORING FAB - FABRIC FRP - FIBER REINFORCED PLASTIC PANEL HDWF - HARDWOOD FLOORING LS - LINOLEUM SHEET FLOORING LT - LINOLEUM TILE LVT - LUXURY VINYL TILE MTL - METAL PC - POLISHED CONCRETE PLAM - PLASTIC LAMINATE PNT - PAINT COLOR QTZ - QUARTZ RBT - RUBBER TILE RF - RESINOUS FLOORING RFWB - RESINOUS FLOOR COVE WALL BASE RP - RESIN PANEL RBSF - RUBBER SHEET FLOORING RBST - RUBBER STAIR TREAD SC - SEALED CONCRETE SDF - STATIC DISSIPATIVE SHEET VINYL SDT - STATIC DISSIPATIVE TILE SLD - SOLID SURFACE ST - STAIN STC - STAINED CONCRETE SV - SHEET VINYL SVWB - INTEGRAL SHEET VINYL WALL BASE T - CERAMIC OR POCELAIN TILE TP - TOILET PARTITION TWB - TILE WALL BASE VCT - VINYL COMPOSITION TILE VWC - VINYL WALL COVERING WB - WALL BASE WDSF - WOOD SPORTS FLOOR WDWB - WOOD WALL BASE WF - WINDOW FILM WP - WALL PROTECTION WS - WINDOW SHADES

WV - WOOD VENEER

eno/24262 - Architectura

1/4" = 1'-0"

FLOOR PLAN - FINISHES

NO. DATE
AUGUST 23, 2024
N CHECKED

A2H, INC.

3009 DAVIES PLANTATION ROAD

P. 901.372.0404 WWW.A2H.COM

HAYWOOD COUNTY

ELECTION

COMMISSION

BUILDING

RENOVATION

50 BOYD AVE.

BROWNSVILLE, TN 38012

100% CONSTRUCTION

DOCUMENTS

REVISIONS


FINISH PLAN &


SCHEDULE

A7.1




	CEILING SCHEDULE											
TYPE	DESCRIPTION / MODEL	EDGE PROFILE	SUSPENSION SYSTEM	COMMENTS								
G1a	EXISTING GYPSUM BOARD. SCRAPED SMOOTH. PAINTED	N/A	ATTACH TO STRUCTURE ABOVE									

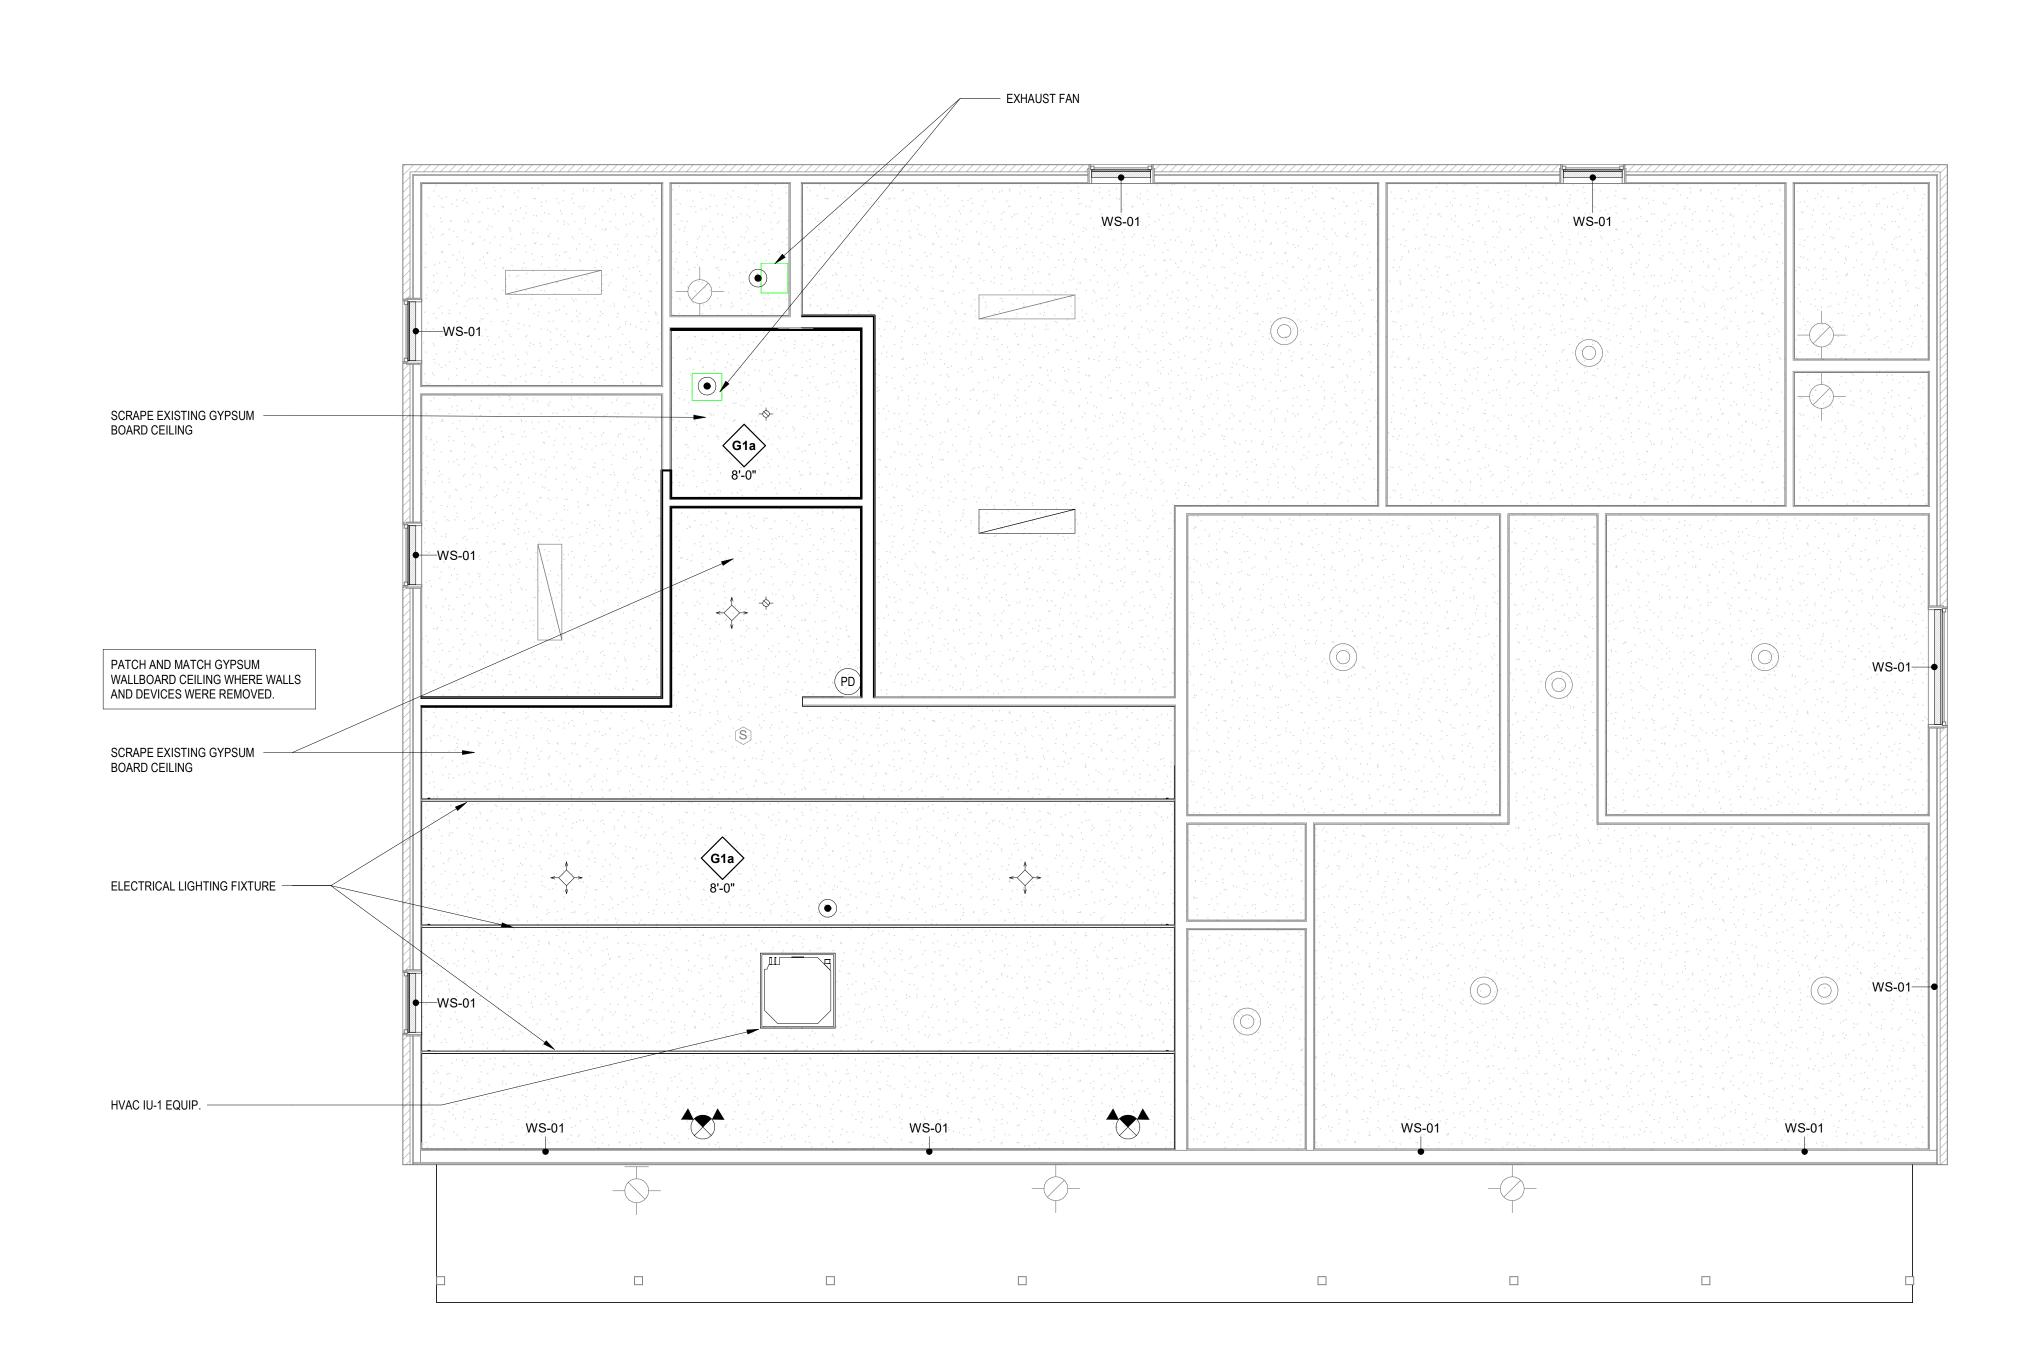

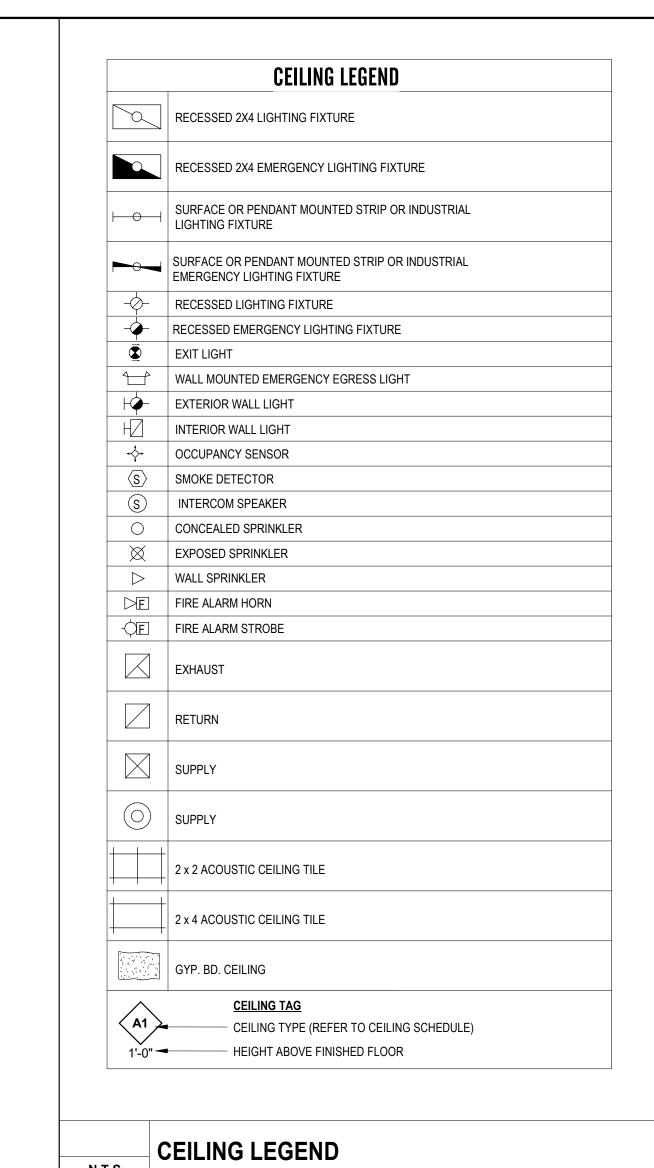

2 H ENGINEERS ARCHITECTS PLANNERS

A2H, INC. 3009 DAVIES PLANTATION ROAD Lakeland, TN 38002 P. 901.372.0404 Www.A2H.COM

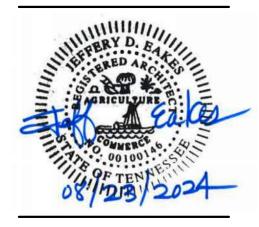

HAYWOOD COUNTY

ELECTION
COMMISSION
BUILDING
RENOVATION

50 BOYD AVE. Brownsville, tn 38012

100% CONSTRUCTION DOCUMENTS

REVISIONS

PROJECT NO. DATE
24262 AUGUST 23, 2024

DRAWN CHECKED
Author Checker

REFLECTED CEILING PLAN

A8.1

	FAN SCHEDULE														
				EXT.	FAN	DRIVE	MAX		MOTOR		MANUFACTUR				
MARK	No.	SERVICE	CFM	S.P. IN. W.G.	RPM	TYPE	SONES	ВНР	ELECTRICAL	INTERLOCK	ER	MODEL NO.	OPENING	ACCESSORIES	COMMENTS
EF	1	EF	75 CFM	0.24	900	DIRECT	0.4	0.1	115/60/1	LIGHT SWITCH	GREENHECK	SP-A90	11" x 13"	2,13	
EF	2	EF	75 CFM	0.24	900	DIRECT	0.4	0.1	115/60/1	OCCUPANCY SENSOR	GREENHECK	SP-A90	11" x 13"	2,13	

(1) <u>FAN TYPE:</u>

1. CENTRIFUGAL ROOF EXHAUSTER

2. CEILING EXHAUST FAN
3. INLINE CENTRIFUGAL FAN
4. SIDEWALL BROBELLER FAN
4. SIDEWALL BROBELLER FAN
5. SIDEWALL BROBELLER FAN
6. SIDEWALL BROBELL FAN
6. SIDEWALL FAN
6. SIDEW

SIDEWALL PROPELLER FAN
 SWSI CENTRIFUGAL UTILITY FAN
 UPBLAST CENTRIFUGAL ROOF EXHAUSTER

2) <u>SERVICE:</u>
SF - SUPPLY FAN
EF - EXHAUST FAN
RF - RETURN FAN
TF - TRANSFER FAN

3) <u>FAN ACCESSORIES:</u>

1. ACCESS DOOR FOR INSPECTION
2. ELECTRICAL DISCONNECT SWITCH

3. BELT GUARD AND MOTOR GUARD

ADJUSTABLE SHEAVES
 WALL SWITCH W/ PILOT LIGHT

MANUFACTURER'S PREFABRICATED INSULATED ROOF CURB (SLOPE AS REQUIRED)

ROOF JACK
 WALL JACK
 BRICK VENT

10 SOFFIT GRILLE
11. ROOF CAP W/ CURB

MOTORIZED BACKDRAFT DAMPER (SAME VOLTAGE AS FAN MOTOR OR W/ TRANSFORMER)
GRAVITY BACKDRAFT DAMPER

14. SOLID STATE SPEED CONTROLLER

SOLID STATE SPEED CONTROLLER
 EXTENDED BASE WITH ACCESS DOOR(NO VENTS) FOR 40" MIN. DISCHARGE HEIGHT

MOTOR AND DRIVE COMPARTMENT WEATHER HOOD

7. DRAIN CONNECTION8. HINGED ACCESS DOORS

9. WALL HOUSING GUARD

20. DAMPER GUARD AND WALL MOUNT HOUSING

A1 F	FAN SCHEDULE
N.T.S.	THE COLLEGE

					SPLIT INDOOR UNIT SC					
UNIT MARK	NO.	CFM LOW/HIGH	E.A.T. °F Db	E.A.T. °F Wb	RATED COOLING CAPACITY (@ 95° F) MBH	HEATING CAPACITY (@ 17° F) MBH	MCA	ELECTRICAL	MANUFACTUR ER	MODEL NO.
IU	1	475/270	80	67	17.7	12.9	0.54	208-230/1/60	MITSUBISHI	SLZ-KF18NA

	MINI-SPLIT OUTDOOR UNIT SCHEDULE									
UNIT MARK	NO.	COOLING CAPACITY @ 95°F O.A.D.B.	HEATING CAPACITY @ 17°F O.A.D.B.	ELECTRICAL	COMP. RLA	MCA	RECOMMEND ED FUSE	MANUFACTURER	MODEL NO.	TYPE COMMENTS
OU	1	17 7	12' - 10 13/16"	208-230/1/60	10	14	15	MITSUBISHI	SUZ-KA18NA2	

NOTES:

INCLUDE FACTORY PROVIDED DISCONNECTS FOR EVERY OUTDOOR UNIT.
 INDOOR UNITS RECEIVE POWER FROM OUTDOOR UNITS THROUGH FIELD-SUPPLIED INTE

2. INDOOR UNITS RECEIVE POWER FROM OUTDOOR UNITS THROUGH FIELD-SUPPLIED INTERCONNECTED WIRING.

3. DIV. 26 SHALL PROVIDE FIELD INSTALLED DISCONNECTS AT EVERY INDOOR UNIT. 4. FURNISH ISOLATING BALL VALVES FOR EACH INDOOR UNIT.

6. CAPACITIES SHOWN ARE BASED ON OUTDOOR CONDITIONS OF 95°F dB / 75°F wB. CAPACITIES WILL VARY BASED ON AMBIENT CONDITIONS.

7. PROVIDED FACTORY START-UP AND A MINIMUM OF TWO (2) DAY'S TRAINING FOR CLIENT'S OPERATIONS GROUP. 8. EQUIP EACH INDOOR UNIT WITH WIRED, WALL-MOUNTED REMOTE. WEB BASED CONTROLS NOT REQUIRED.

B1 MINI SPLIT SYSTEM SCHEDULE

B4 1/8" = 1'-0"

DEMOLITION HVAC FLOOR PLAN

HVAC FLOOR PLAN

1/8" = 1'-0"




1. CONTRACTOR TO RELOCATE ALL PRESERVED DUCTWORK, DIFFUSERS, AND ASSOCITED ACCESORIES (WHERE NOT NOTED OTHERWISE) INTO NEW CEILINGS AS REQUIRED.

CONTRACTOR TO PRESERVE ALL DUCTWORK, DIFFUSERS, AND ASSOCITED ACCESORIES (WHERE NOT NOTED OTHERWISE) WHERE

CEILINGS ARE DEMOLISHED.

2. OU-1 TO BE MOUNTED ON 4" THICK CONCRETE PAD. VERIFY SIZE WITH MNFR. REQUIREMENTS.

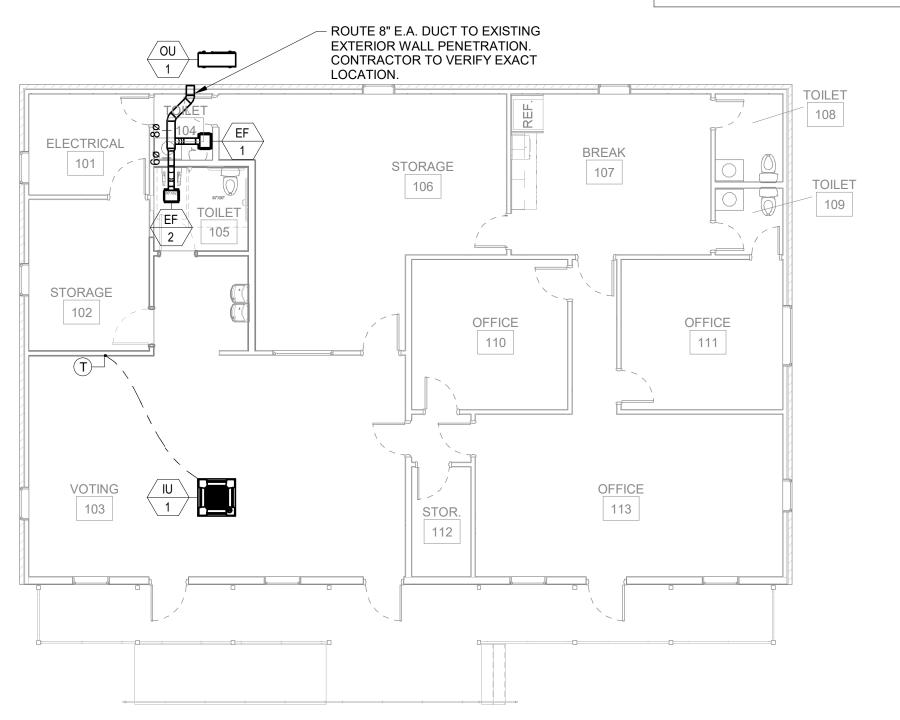


- REMOVE EXISTING EXH. FANS AND ALL ASSOCIATED DUTWORK BACK TO EXTERIOR PENETRATION

NORTH

THESE DRAWINGS ARE DIAGRAMMATIC COORDINATION OF ALL TRADES AND COMPLIANCE WITH DIMENSIONS ON ARCHITECTURAL AND STRUCTURAL DRAWINGS ARE REQUIRED

2 H ENGINEERS ARCHITECTS PLANNERS

A2H, INC. 3009 DAVIES PLANTATION ROAD LAKELAND, TN 38002 P. 901.372.0404 WWW.A2H.COM

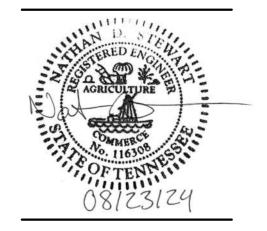

HAYWOOD COUNTY

ELECTION
COMMISSION
BUILDING
RENOVATION

BROWNSVILLE, TN

CONSTRUCTION DOCUMENTS

REVISIONS

PROJECT NO. DATE
24262 AUG 23, 2023

DRAWN CHECKED

HVAC FLOOR PLAN

M1₋1

3009 DAVIES PLANTATION ROAD LAKELAND, TN 38002 P. 901.372.0404 WWW.A2H.COM



COMMISSION

BROWNSVILLE. TN

DOCUMENTS

REVISIONS

DATE AUG 23, 2023

CHECKED

HVAC DETAILS

PLUMBING GENERAL NOTES

PLUMBING RISER DIAGRAM

N.T.S.

PRODUCTS A. SANITARY SEWER PIPING, BURIED 1. PVC PIPE: ASTM D-2665, D-1785, SCHEDULE 40 PVC DWV. A. FITTINGS: PVC DWV B. JOINTS: ASTM D2855, SOLVENT WELD WITH ASTM D2564 SOLVENT CEMENT. 2. CAST IRON PIPE: ASTM A74, SERVICE WEIGHT. ALL PIPE AND FITTINGS SHALL BE MARKED WITH THE COLLECTIVE TRADEMARK OF THE CAST IRON SOIL PIPE INSTITUTE AND LISTED BY NSF INTERNATIONAL. A. FITTINGS: CAST IRON. B. JOINTS: ASTM C-564, NEOPRENE GASKETING SYSTEM. B. SANITARY SEWER PIPING, ABOVE GRADE 1. PVC PIPE: ASTM D-2665, D-1785, SCHEDULE 40 PVC DWV. (PROHIBITED IN RETURN AIR PLENUMS) A. FITTINGS: PVC B. JOINTS: ASTM D2855, SOLVENT WELD WITH ASTM D2564 SOLVENT CEMENT. 2. CAST IRON PIPE: CISPI 301, ASTM A 888, HUBLESS, SERVICE WEIGHT. ALL PIPE AND FITTINGS SHALL BE MARKED WITH THE COLLECTIVE TRADEMARK OF THE CAST IRON SOIL PIPE INSTITUTE AND LISTED BY NSF INTERNATIONAL. A. FITTINGS: CAST IRON. B. JOINTS: NEOPRENE GASKETS AND S/S CLAMP AND SHIELD ASSEMBLIES. C. WATER PIPING ABOVE GRADE 1. COPPER TUBING: ASTM B88 , TYPE L, HARD DRAWN. A. FITTINGS: ASME B16.18, CAST BRONZE, OR ASME B16.22, WROUGHT COPPER AND BRONZE. B. JOINTS: ASTM B32, SOLDER, GRADE 95TA. D. CONDENSATE EQUIPMENT DRAINS AND OVERFLOWS 1. COPPER TUBING: SEAMLESS COPPER DRAINAGE TUBE (DWV), MINIMUM 1-1/4" SIZE. A. FITTINGS: ANSI/ASME B16.23 CAST BRASS, OR ANSI/ASME B16.29 SOLDER WROUGHT COPPER WITH WYE AND BRASS CLEANOUT PLUG AT ALL CHANGES B. JOINTS: ASTM B32, SOLDER, GRADE 95TA. C. TRAPS: FACTORY FABRICATED, DEEP SEAL TYPE. E. GLASS FIBER PIPE INSULATION: 1. INSULATION: ASTM C547; RIGID MOLDED, NON COMBUSTIBLE.

WITH ALL SERVICE JACKET. "K" VALUE = .024 @ 75^ F.

ALUMINIZED FILM.

3 SCHEDULES

PIPE SIZE

1/2" TO 1-1/4" 1-1/2" TO 2"

INSULATION SCHEDULE:

CONDENSATE DRAINS

F. PIPE HANGERS AND SUPPORTS

DOMESTIC HOT WATER SUPPLY

A. CONFORM TO ASME B31.9.

DOMESTIC COLD WATER SUPPLY

1. PLUMBING PIPING - DWV & WATER PIPING.

IRON, ADJUSTABLE SWIVEL, CLEVIS.

2. VAPOR BARRIER JACKET, ASTM C921, WHITE KRAFT PAPER

PIPE SIZE

ALL

ALL

THICKNESS

HANGER ROD

DIAMETER

NEW PIPE TO TIE INTO EXISITNG PIPE AS NECESSARY

1/2"

REINFORCED WITH GLASS FIBER YARN AND BONDED TO

B. HANGERS FOR PIPE SIZES 1/2" TO 1-1/2": MALLEABLE

2. PROVIDE SHEET METAL SHIELDS AT HANGER LOCATIONS.

(FEET)

PLUMBING SPECIFICATION

MAX. SUPPORT BRACING)

—— F—— —— D—— (FM) Ψ

LEGENDS DESCRIPTION FIRE STANDPIPE WET SPRINKLER PIPING SPRINKLER DRAIN PIPING PIPE BREAK FIRE HOSE VALVE IN CABINET FIRE HOSE VALVE SPRINKLER FLOOR CONTROL VALVE ASSEMBLY SPRINKLER FLOOR CONTROL VALVE ASSEMBLY NUMBER SHUTOFF VALVE GLOBE VALVE CHECK VALVE CHECK VALVE WITH AUTOMATIC BALL DRIP RELIEF VALVE ALARM CHECK VALVE FLOW METER O.S.&Y. GATE VALVE O.S.&Y. GATE VALVE WITH TAMPER SWITCH TAMPER SWITCH WATER FLOW SWITCH PRESSURE GAUGE ENCLOSED WASTE CONE WITH SIGHT GLASS ROOF MANIFOLD (3 WAY) FLUSH TYPE FIRE DEPARTMENT CONNECTION FLUSH TYPE PUMP TEST HEADER WATER PROOF SLEEVE ARROW INDICATES DIRECTION OF FLOW DOUBLE CHECK DETECTOR ASSEMBLY (DCDA) **UPRIGHT POST INDICATOR** (SP) RISER DESIGNATION SPRINKLER SERVICE 0 STANDPIPE SERVICE RISER NUMBER #

PLUMBING LEGEND

FIXTURES TO REMAIN FIXTURES TO REMAIN FIXTURES TO BE DEMOLISHED. PRESERVE EXISITING CW, HW, AND BELOW SLAB SANITARY CONNECTIONS. SANITARY SHALL BE RELOCATED AS REQUIRED FOR NEW FIXTURE LOCATIONS. <u>-----</u> THESE DRAWINGS ARE DIAGRAMMATIC COORDINATION OF ALL TRADES AND COMPLIANCE WITH DIMENSIONS

> PLUMBING FIXTURES TAGGED IN THIS VIEW TO BE NEW FIXTURES. FIXTURES NOT TAGGED IN THIS VIEW ARE EXISTING. CONTRACTOR TO VERIFY EXISITNG PIPE AND CONDITIONS IN THE

THESE DRAWINGS ARE DIAGRAMMATIC COORDINATION OF ALL TRADES AND COMPLIANCE WITH DIMENSIONS

ON ARCHITECTURAL AND STRUCTURAL DRAWINGS ARE

CONTRACTOR TO VERIFY EXISITNG PIPE AND CONDITIONS IN THE

REMOVE AND DISCARD PLUMBING FIIXTURES AND ASSOCIATED

INTERCONNECTING PIPING THAT IS SHOWN AS DEMOLISHED.

CAP PIPING BELOW FLOORS. CAP PIPING IN WET WALLS FLUSH

WITH PARTITION.

LEAVE NO DEAD-END PIPING.

ELECTION COMMISSION BUILDING **RENOVATION**

BROWNSVILLE, TN

HAYWOOD COUNTY

3009 DAVIES PLANTATION ROAD

LAKELAND, TN 38002

P. 901.372.0404


WWW.A2H.COM


CONSTRUCTION **DOCUMENTS**

REVISIONS

CHECKED DRAWN


PLUMBING FLOOR PLAI

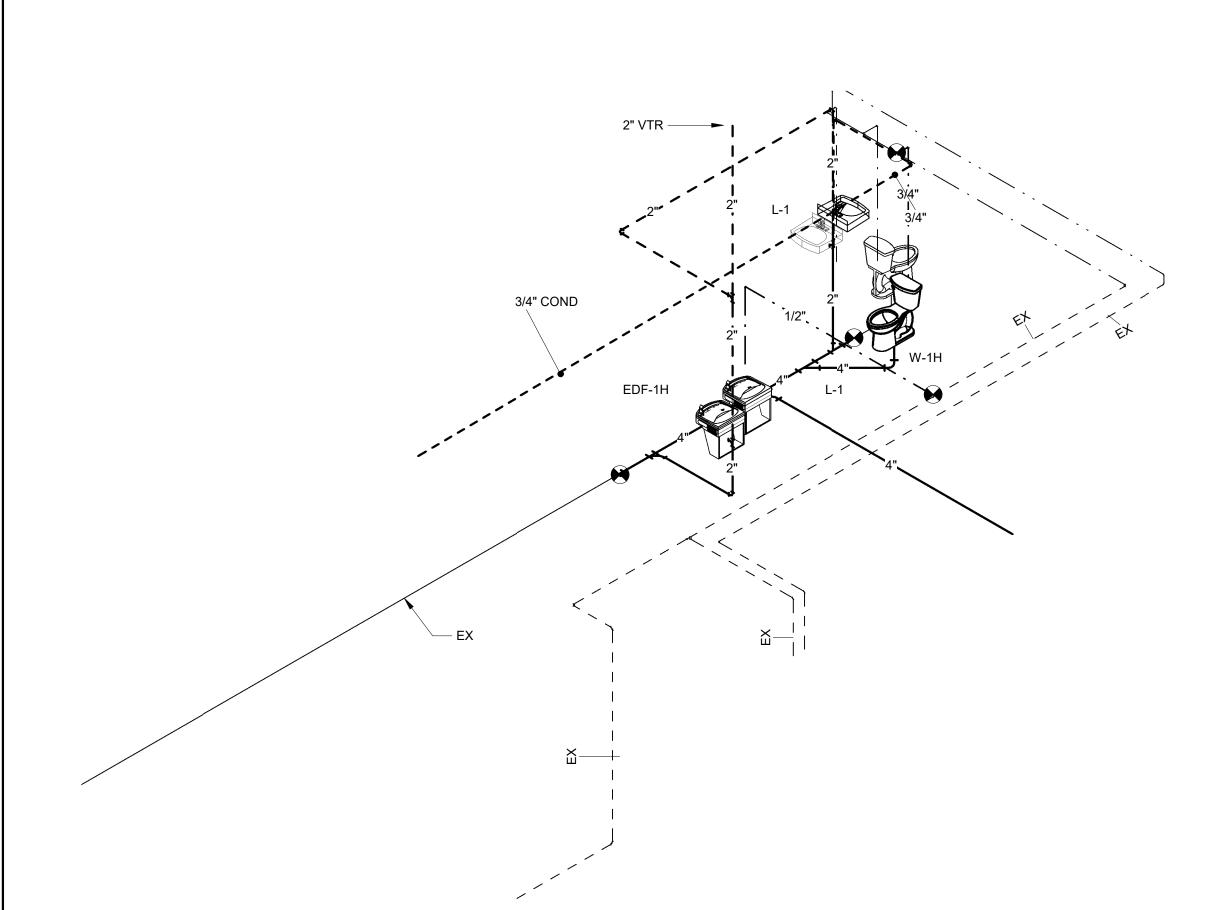

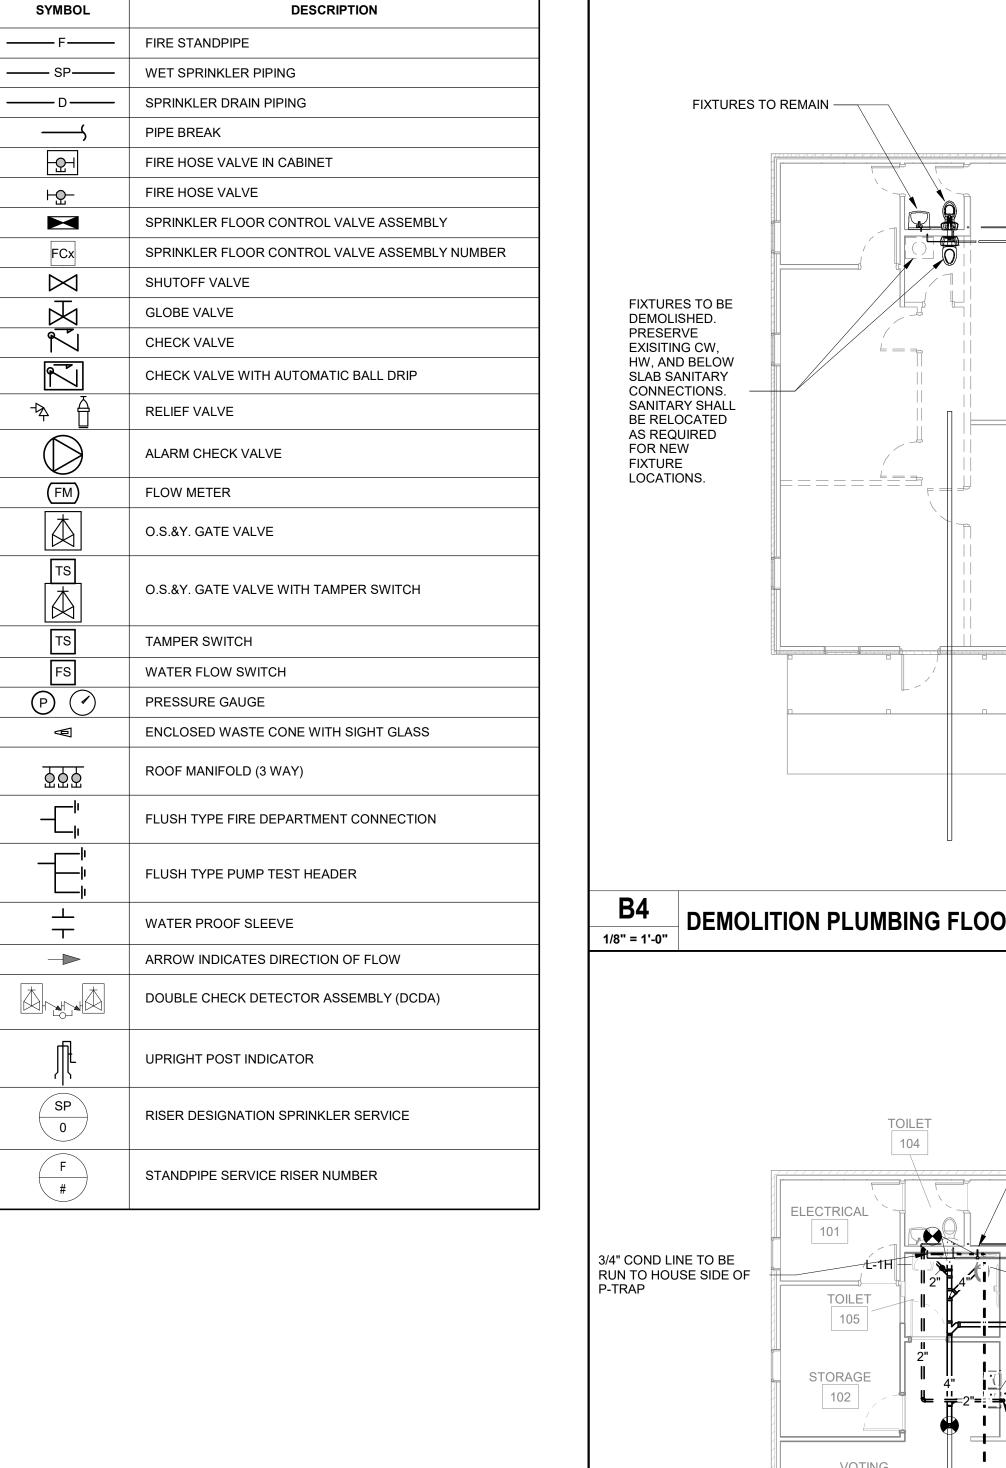


PLUMBING FLOOR PLAN


1/8" = 1'-0"

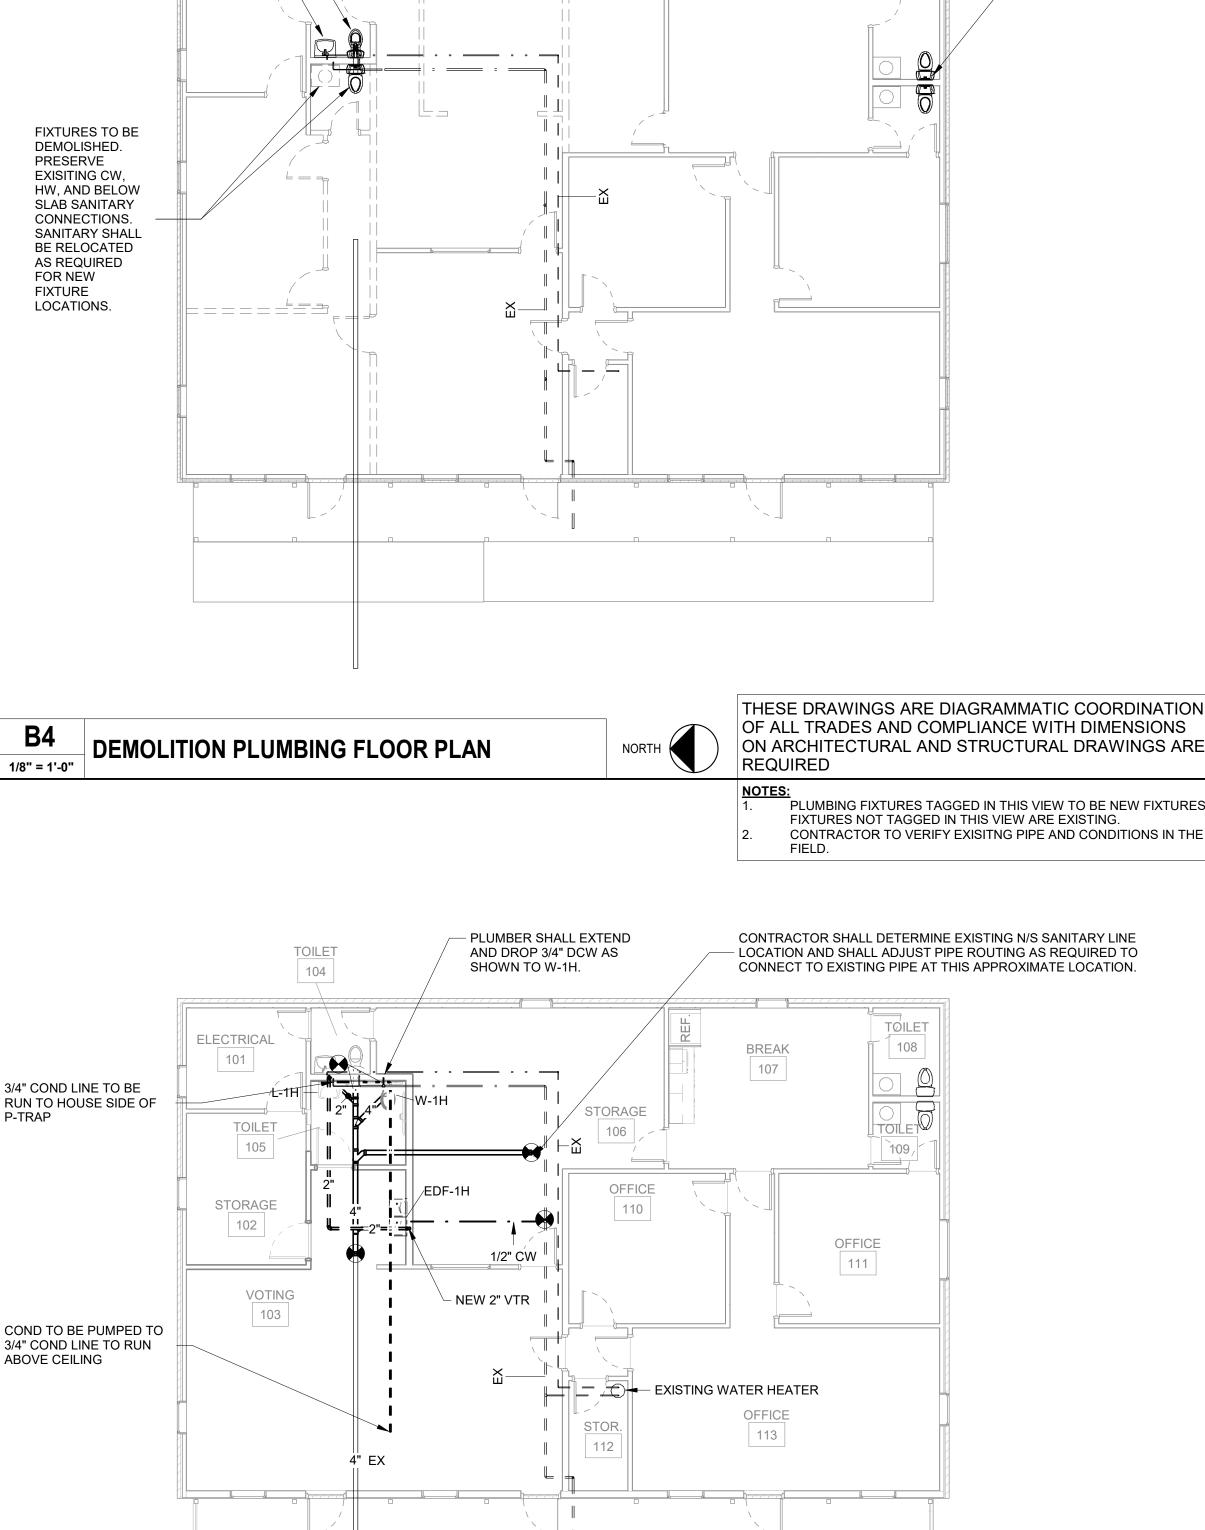

	PLUMBING FIXTURE SCHEDULE										
TYPE MARK	DESCRIPTION	SOIL	WASTE	VENT	CW	HW	MXV	REMARKS			
EDF-1H	ELECTRIC DRINKING FOUNTAIN HI/LOW HANDICAPPED		2"	2"	1/2"		1	"ELKAY" # EZSTL8C, WATER COOLER, ZURN NO. Z8702-9-PC TRAP, Z8802LRLK SUPPLY AND STOP, ZURN Z-1225 CARRIER. MOUNT AT HANDICAPPED HEIGHT.			
L-1H	LAVATORY, WALL HUNG, HANDICAPPED		2"	2"	1/2"	1/2"		"ZURN" # 5344, BOWL, 4" CENTERS, Z8746-PC OFF-SET GRID STRAINER, Z8700-8-PC TRAP, Z8802LRLK SUPPLIES W/LOOSE KEY STOPS. ZURN Z-1231 CARRIER, ZURN Z7440-XL LEVER CONTROL FAUCET. "ZURN" # Z8946-3-NT, COMBINATION KIT, SATIN WHITE, PVC RESIN PROTECTORS FOR TRAP AND SUPPLIES.			
W-1H	WATER CLOSET, FLOOR MTD., FLUSH TANK HANDICAPPED	4"		2"	1/2"			"ZURN" # Z5550, 1.6 GPF, TWO-PIECE, SIPHON JET TOILET. "ZURN" # Z5955SS-EL, ELONGATED WHITE TOILET SEAT. "ZURN" # Z8802CRLK-PC, SUPPLY AND LOOSE KEY STOP.			

A1 PLUMBING FIXTURE SCHEDULE

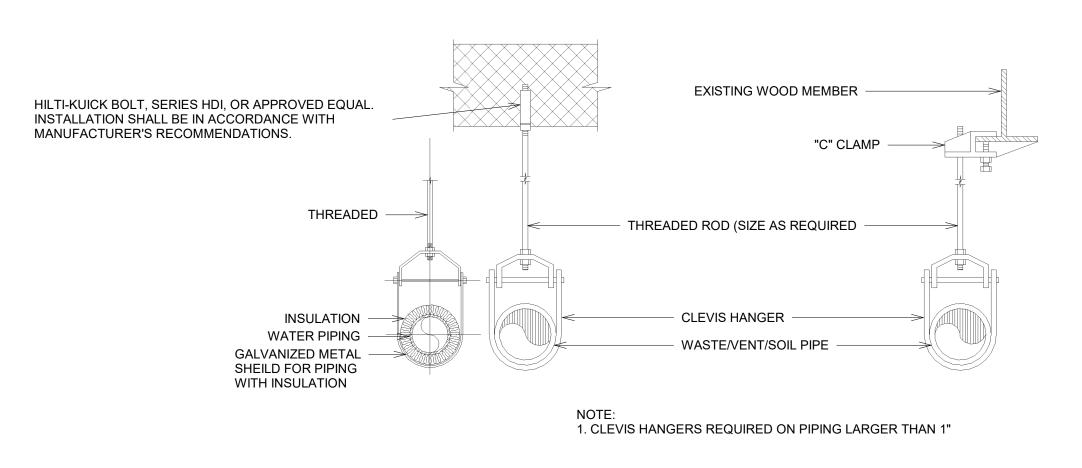

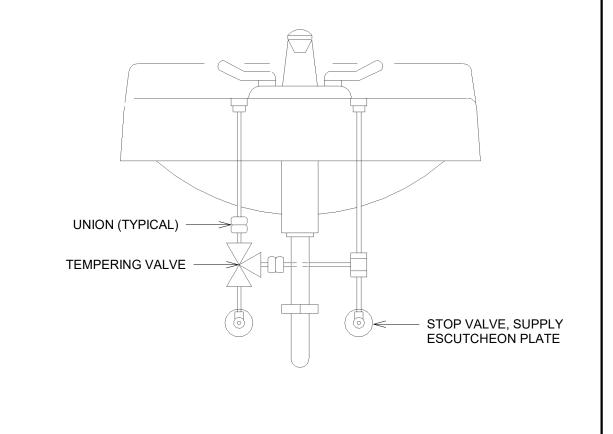


B1 TYPICAL HANGER DETAIL

TYPICAL POINT OF USE TEMPERING VALVE



A2H, INC.
3009 DAVIES PLANTATION ROAI
LAKELAND, TN 38002
P. 901.372.0404
WWW A2H COM

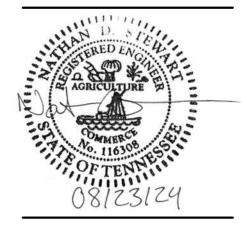

HAYWOOD COUNTY

ELECTION
COMMISSION
BUILDING
RENOVATION

BROWNSVILLE, TN


CONSTRUCTION DOCUMENTS

REVISIONS

PROJECT NO.	DATE
24262	AUG 23, 2023
DRAWN	CHECKED
JCS	NDS

PLUMBING FIXTURE SCHEDULE AND DETAILS

P2.1

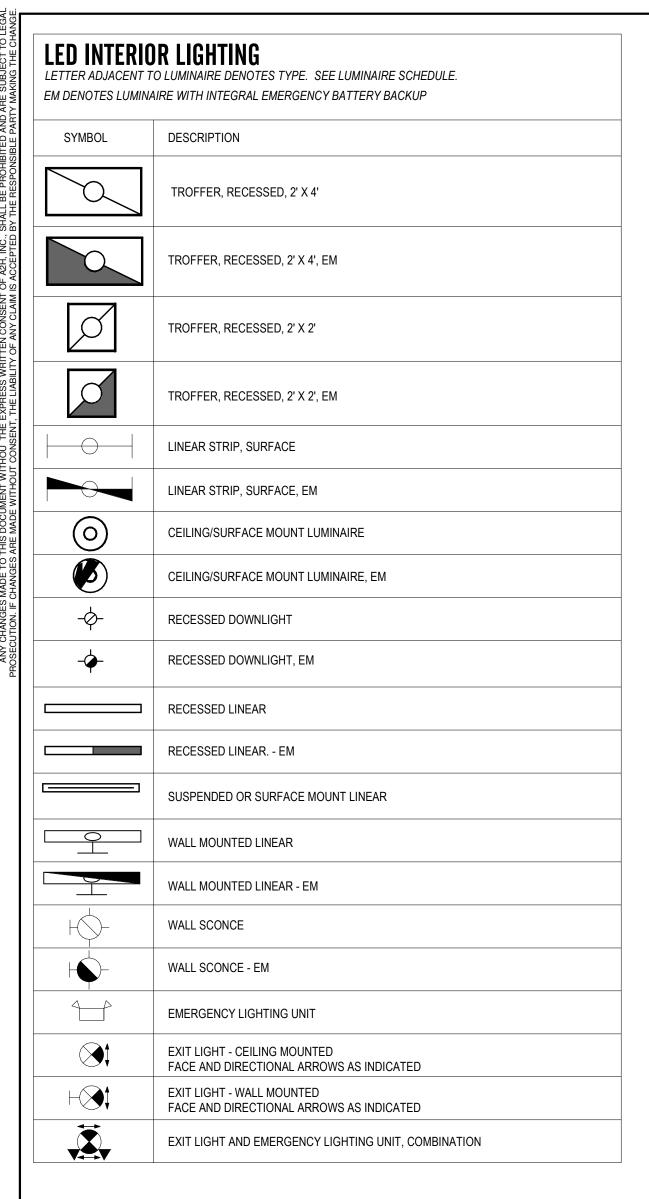

SYMBOL	DESCRIPTION
	PANELBOARD, 240/120V 1PH 3W
	SAFETY SWITCH, NON-FUSED, 60/3 OR SIZE NOTED
	SAFETY SWITCH, FUSED, 60/3 OR SIZE NOTED
•	DIRECT CONNECTION TO EQUIPMENT
CONDUC	TORS, CABLES, BOXES, AND GROUNDING
SYMBOL	DESCRIPTION
	CONDUCTORS IN CONDUIT CONCEALED IN OR ABOVE CEILING OR IN WALL
<u></u>	CONDUCTORS IN CONDUIT CONCEALED BELOW FLOOR, IN SLAB OR BELOW GRADE
7	EQUIPMENT GROUNDING CONDUCTOR
	CONDUCTORS IN CONDUIT EXPOSED ON CEILING OR WALL
J	JUNCTION BOX, ABOVE CEILING, UON
GB	GROUND BAR
IBT	GROUND BAR - INTERSYSTEM BONDING TERMINATION
IRING DE	VICES
SYMBOL	DESCRIPTION
TR WR	DESCRIPTION SUBSCRIPTS: TR - TAMPER RESISTANT, U - UNIVERSAL SERIAL BUS (USB) MOBILE DEVICE POWER (2-PORT), WR - WEATHER-RESISTANT
TR WR	SUBSCRIPTS: TR - TAMPER RESISTANT, U - UNIVERSAL SERIAL BUS (USB) MOBILE
TR WR U	SUBSCRIPTS: TR - TAMPER RESISTANT, U - UNIVERSAL SERIAL BUS (USB) MOBILE DEVICE POWER (2-PORT), WR - WEATHER-RESISTANT
TR WR U	SUBSCRIPTS: TR - TAMPER RESISTANT, U - UNIVERSAL SERIAL BUS (USB) MOBILE DEVICE POWER (2-PORT), WR - WEATHER-RESISTANT RECEPTACLE, DUPLEX, NEMA 5-20R
TR WR	SUBSCRIPTS: TR - TAMPER RESISTANT, U - UNIVERSAL SERIAL BUS (USB) MOBILE DEVICE POWER (2-PORT), WR - WEATHER-RESISTANT RECEPTACLE, DUPLEX, NEMA 5-20R RECEPTACLE, DUPLEX, GFCI, NEMA 5-20R
TR WR U	SUBSCRIPTS: TR - TAMPER RESISTANT, U - UNIVERSAL SERIAL BUS (USB) MOBILE DEVICE POWER (2-PORT), WR - WEATHER-RESISTANT RECEPTACLE, DUPLEX, NEMA 5-20R RECEPTACLE, DUPLEX, GFCI, NEMA 5-20R RECEPTACLE, DUPLEX, NEMA 5-20R, COUNTERTOP HEIGHT
TR WR U	SUBSCRIPTS: TR - TAMPER RESISTANT, U - UNIVERSAL SERIAL BUS (USB) MOBILE DEVICE POWER (2-PORT), WR - WEATHER-RESISTANT RECEPTACLE, DUPLEX, NEMA 5-20R RECEPTACLE, DUPLEX, GFCI, NEMA 5-20R RECEPTACLE, DUPLEX, NEMA 5-20R, COUNTERTOP HEIGHT RECEPTACLE, DUPLEX, GFCI, NEMA 5-20R, COUNTERTOP HEIGHT
TR WR U	SUBSCRIPTS: TR - TAMPER RESISTANT, U - UNIVERSAL SERIAL BUS (USB) MOBILE DEVICE POWER (2-PORT), WR - WEATHER-RESISTANT RECEPTACLE, DUPLEX, NEMA 5-20R RECEPTACLE, DUPLEX, GFCI, NEMA 5-20R RECEPTACLE, DUPLEX, NEMA 5-20R, COUNTERTOP HEIGHT RECEPTACLE, DUPLEX, GFCI, NEMA 5-20R, COUNTERTOP HEIGHT RECEPTACLE, TWO DUPLEX IN ONE OUTLET (QUADPLEX)
TR WR U	SUBSCRIPTS: TR - TAMPER RESISTANT, U - UNIVERSAL SERIAL BUS (USB) MOBILE DEVICE POWER (2-PORT), WR - WEATHER-RESISTANT RECEPTACLE, DUPLEX, NEMA 5-20R RECEPTACLE, DUPLEX, GFCI, NEMA 5-20R RECEPTACLE, DUPLEX, NEMA 5-20R, COUNTERTOP HEIGHT RECEPTACLE, DUPLEX, GFCI, NEMA 5-20R, COUNTERTOP HEIGHT RECEPTACLE, TWO DUPLEX IN ONE OUTLET (QUADPLEX) RECEPTACLE, QUADPLEX, GFCI, NEMA 5-20R, COUNTERTOP HEIGHT

TOGGLE SWITCH, MOTOR RATED, WITH POLES FOR LOAD SERVED.

LIGHTING CONTROL DEVICES					
DEVICES ARE	LINE VOLTAGE, WALL MOUNTED, UON.				
SYMBOL	DESCRIPTION				
\$	SWITCH TOGGLE, SPST, 20A, 120V				
\$ ₃	SWITCH, THREE WAY				
\$ _{os}	SWITCH, VACANCY SENSING				
\$ _D	SWITCH, DIMMING, 0-10V				
\$ _{OSD}	SWITCH, VACANCY SENSING, 0-10V DIMMING				
\$ _{OS2}	SWITCH, VACANCY SENSING, 2 POLE				
\$ _K	SWITCH, KEY OPERATED, MOMENTARY TURN FOR ON, SPRING LOAD OFF, UON				

NFTWOR	K LIGHTING CONTROLS
DEVICES ARE LO	DW VOLTAGE NETWORK TYPE, UON. GE, D - DIMMING, # - BUTTONS,
\$ _{LV}	SWITCH, ON/OFF
\$ LVD	SWITCH, LOW VOLTAGE NETWORK, ON/OFF, DIMMING
\$ _{2D}	SWITCH, LOW VOLTAGE NETWORK, ON/OFF, DIMMING, 2 ZONE
*	OCCUPANCY SENSOR, LOW VOLTAGE NETWORK, CEILING
*	OCCUPANCY SENSOR, LOW VOLTAGE NETWORK, WALL
(DS)	DAYLIGHT SENSOR, CEILING
(a)	POWER PACK, NON DIMMABLE
(h)	POWER PACK, NON DIMMABLE, UL 924 EMERGENCY OVERRIDE
	POWER PACK, DIMMING, 0-10V
	POWER PACK, DIMMING, 0-10V, UL924 EMERGENCY OVERRIDE
[LCP]	LIGHTING CONTROL PANEL, SINGLE PANEL OR COLLECTION OF NETWORK DEVICES AS NOTED
ТС	LIGHTING CONTROLLER WITH TIME CLOCK AND PHOTOCELL INPUT

SYMBOL	DESCRIPTION
\triangleright	DATA OUTLET. 1-IN C WITH PULLSTRING TO ACCESSIBLE CEILING SPACE
₽	DATA OUTLET, COUNTER HEIGHT. 1-IN C WITH PULLSTRING TO ACCESSIBLE CEILING SPACE
\Diamond	TELEVISION (TV) OUTLET. SINGLE GANG BOX AT 18-IN AFF. 1.25-IN C WITH PULLSTRING TO ACCESSIBLE CEILING SPACE.
0	DATA OUTLET RECESSED IN CEILING.
6	SPEAKER, FLUSH CEILING MOUNTED
8	CARD READER. SINGLE GANG BOX 48-IN AFF. 1/2-IN C WITH PULLSTRING TO ACCESSIBLE CEILING SPACE.
\supset	CAMERA, INTERIOR, CELING MOUNTED UNLESS OTHERWISE NOTED.
	CAMERA, EXTERIOR, WALL MOUNTED UNLESS OTHERWISE NOTED.
	FLOOR BOX, SINGLE FITTING, DATA OUTLET, 1-IN CONDUIT AND STRING TO ABOVE CEILING.
B	FLOOR BOX, CAST IN PLACE, SHARED WITH POWER, WIRING DEVICE SERVICE FITTINGS: (2) 1-GANG OUTLETS, 1.25-IN CONDUIT AND STRING TO ABOVE CEILING
(FB)	FLOOR BOX, POKE THROUGH, SHARED WITH POWER, WIRING DEVICE SERVICE FITTINGS: (2) 1-GANG OUTLETS, 1.25-IN EMT AND STRING TO ABOVE CEILING

ABBREVIATIONS

AMPERE FRAME

AFG ABOVE FINISHED GRADE

AMPERE-HOURS

AL ALUMINUM

APPX APPROXIMATELY

AMPERE TRIP

AWG AMERICAN WIRE GAUGE

BRANCH CIRCUIT

BFC BELOW FINISHED CEILING

BFG BELOW FINISHED GRADE

BOD BASIS OF DESIGN

CALORIE

CANDELA CENTERLINE

COPPER

EXISTING

FFFT

GROUND

GAUGE

GALV GALVANIZED

FAHRENHEIT

FOOTCANDLE

DIMENSION

EBM EXTENDED BATTERY MODULE

ECB ENCLOSED CIRCUIT BREAKER

EFD ENCLOSED FUSED DISCONNECT

EGB EXTERNAL GROUND BUS BAR

CAL

CU

DIM

FMC

FT

GA

GES

GFI

LCP

LPA

MNF

MBJ

MCA

O.C.

R

BCB BRANCH CIRCUIT BREAKER

AFC AVAILABLE FAULT CURRENT

ABOVE FINISHED FLOOR

AUTHORITY HAVING JURISDICTION AMPERES INTERRUPTING CAPACITY

ASCA AVAILABLE SHORT CIRCUIT AMPERES

AUTOMATIC TRANSFER SWITCH

CONDUIT OR COUNTERTOP HEIGHT

EQUIPMENT BONDING JUMPER

ELECTRIC DRINKING FOUNTAIN

ECM ELECTRICALLY COMMUTATED MOTOR

EGC EQUIPMENT GROUNDING CONDUCTOR EMT ELECTRICAL METALLIC TUBING

FEEDER CIRCUIT BREAKER

FLEXIBLE METAL CONDUIT

GROUND BUS OR BUSBAR

GFPE GROUND FAULT PROTECTION

INSULATED CEILING RATED

LIGHTING CONTROL PANEL

LFMC LIQUIDTIGHT FLEXIBLE METAL CONDUIT

LIGHTING POWER ALLOWANCE

LIGHTING POWER DENSITY

MINIMUM CIRCUIT AMPACITY

MOP MAXIMUM OVERCURRENT PROTECTION

NATIONAL ELECTRIC CODE NORMALLY CLOSED NORMALLY OPEN NOT TO SCALE

PHOTOCONTROL SWITCH

SCCR SHORT CIRCUIT AMPERE RATING

UNDERGROUND FEEDER UON UNLESS OTHERWISE NOTED

WEATHER - RESISTANT

SMR SURFACE METAL RACEWAY SPD SURGE PROTECTION DEVICE

STAINLESS STEEL

MAIN BONDING JUMPER

MCCB MOLDED CASE CIRCUIT BREAKER

OF EQUIPMENT

INCH OR INCHES

MANUFACTURER

MCB MAIN CIRCUIT BREAKER

MLO MAIN LUG ONLY

MTG MOUNTING N/A NOT APPLICABLE

N.T.S. NOT TO SCALE ON CENTER

PNL PANELBOARD QTY QUANTITY RACEWAY

SQ SQUARE

TYP TYPICAL

SWB SWITCHBOARD SWG SWITCHGEAR TR TAMPER RESISTANT

VOLTS

VOLT-AMPS WATT

EXISTING FEET

INCH

ON CENTER

RMC RIGID METAL CONDUIT SWITCHED

MGB MASTER GROUND BUS BAR

KELVIN KILOAMPERES

LM LUMEN

GROUNDING ELECTRODE CONDUCTOR

GROUND FAULT CIRCUIT INTERRUPTING

INTERSYSTEM BONDING TERMINATION

GROUNDING ELECTRODE SYSTEM

AFB ARC FLASH BOUNDARY

- 1. PROVIDE LABOR AND MATERIALS NECESSARY FOR A COMPLETE AND FULLY FUNCTIONAL ELECTRICAL SYSTEM. INCLUDE LABOR, INSTALLATION METHODS, EQUIPMENT, AND MATERIALS FOR WORK REQUIRED FOR THE INSTALLATION AS SHOWN ON DRAWINGS AND AS DESCRIBED IN THE SPECIFICATIONS. ADHERE TO MORE STRINGENT REQUIREMENTS THAN THOSE DESCRIBED HEREIN OR AS SET FORTH UNDER CODES, LAWS, AND ORDINANCES OF FEDERAL, STATE, AND LOCAL AUTHORITIES HAVING JURISDICTION. ERECT, INSTALL, TOOL, CONNECT, CLEAN, ADJUST, TEST, CONDITION, AND PLACE MATERIALS AND EQUIPMENT IN ACCORDANCE WITH THE MANUFACTURER'S DIRECTIONS AND RECOMMENDATIONS.
- 2. COMPLY WITH THE RULES AND REGULATIONS OF THE AUTHORITIES HAVING JURISDICTION INCLUDING: 1. STATE OF TENNESSEE DEPARTMENT OF COMMERCE AND INSURANCE, DIVISION OF FIRE
- PROTECTION, THE STATE FIRE MARSHAL'S OFFICE//. 2. HAYWOOD COUNTY OFFICE OF CONSTRUCTION CODE ENFORCEMENT AND THE CITY OF
- BROWNSVILLE DIVISION OF FIRE SERVICES. 3. THE CITY OF BROWNSVILLE AND THE UNIFIED DEVELOPMENT CODE.
- 4. TENNESSEE BOARD OF HEALTH.

ELECTRICAL GENERAL NOTES

- AMERICAN WITH DISABILITIES ACT GOVERMENTAL FEES:
- 1. SECURE AND PAY FOR PERMITS, GOVERNMENTAL FEES, TAXES AND LICENSES NECESSARY FOR THE PROPER EXECUTION AND COMPLETION OF ELECTRICAL WORK.
- 2. PREPARE AND SUBMIT TO GOVERNMENTAL AGENCIES, UTILITY COMPANIES, AND LOCAL CODE OFFICIALS, SHOP DRAWINGS AND/OR INSTALLATION DETAILS WHICH ARE REQUIRED BY THESE AGENCIES FOR THEIR APPROVAL.
- 3. NO PART OF THE DESIGN IS TO BE CHANGED WITHOUT THE PRIOR APPROVAL OF THE ENGINEER.
- 4. ENSURE MATERIALS AND EQUIPMENT ARE LISTED AND/OR LABELED BY U.L., ETL, CSA, OR ANOTHER NATIONALLY RECOGNIZED TESTING LABORATORY (NRTL). PROVIDE COMMERCIAL GRADE MATERIAL, EQUIPMENT, WIRING DEVICES, UNLESS SPECIFICALLY INDICATED AS EXISTING TO BE REUSED ON
- 5. NOTIFY THE ARCHITECT, ENGINEER, AND PROJECT MANAGER IN WRITING OF MATERIALS OR APPARATUS BELIEVED TO BE INADEQUATE, UNSUITABLE, IN VIOLATION OF LAWS, ORDINANCES, RULES, OR REGULATIONS OF THE AUTHORITIES HAVING JURISDICTION.
- 6. EXAMINE THE CONTRACT DOCUMENTS AND MAKE A SCHEDULED ARRANGEMENT WITH THE PROJECT MANAGER TO VISIT THE SITE TO BECOME FAMILIAR WITH THE BUILDING AND SITE CONDITIONS RELATING TO THE WORK. FAILURE TO DO SO WILL NOT RELIEVE OBLIGATIONS OF THE CONTRACT.
- TEMPORARY POWER AND LIGHTING: PROVIDE FOR THE PERFORMANCE OF OTHER TRADES, FOR THE ENTIRE PERIOD OF CONSTRUCTION. REMOVE TEMPORARY WIRING AT THE COMPLETION OF CONSTRUCTION. INCLUDE COST FOR ESTABLISHING AND REMOVING TEMPORARY POWER IN BID.
- 8. <u>SUBMITTALS</u>: ARRANGE IN LOGICAL GROUPS TO REFLECT SPECIFICATION SECTIONS. INCLUDE MANUFACTURER'S NAMES, CATALOG NUMBERS, CUTS, DIAGRAMS, AND OTHER DESCRIPTIVE DATA TO IDENTIFY AND DESCRIBE THE EQUIPMENT. DELIVER COMPLETE SUBMITTAL PACKAGE AT ONE TIME. PARTIAL SUBMITTALS WILL NOT BE REVIEWED. INCOMPLETE OR INSUFFICIENT SUBMITTALS WILL BE RETURNED FOR CORRECTION.
- AS-BUILTS: PROVIDE AS-BUILT DOCUMENTATION AND HARD COPY REPRODUCIBLE DRAWINGS AT THE COMPLETION OF THE PROJECT AND SUBMIT TO THE ARCHITECT AND THE ENGINEER. INDICATE EXACT CIRCUIT NUMBERS, LOCATIONS OF DISTRIBUTION EQUIPMENT, DEVICES, CEILING FIXTURES, AND RACEWAYS FOR LIGHTING, TELECOMMUNICATIONS AND POWER DISTRIBUTION SYSTEMS AS INSTALLED.
- 10. COORDINATION WITH OTHER SYSTEMS:
- 1. VERIFY CLEARANCES FOR ELECTRICAL WORK BEFORE PROCEEDING WITH CONSTRUCTION. COORDINATE USAGE OF AVAILABLE SPACE WITH OTHER TRADES. IN THE EVENT OF CONFLICTS, NOTIFY THE ARCHITECT AND ENGINEER BEFORE PROCEEDING WITH THE WORK.
- 2. REFER TO MECHANICAL AND PLUMBING ENGINEERING DRAWINGS FOR LOCATIONS OF MECHANICAL AND PLUMBING EQUIPMENT



A2H, INC. **3009 DAVIES PLANTATION ROAD** LAKELAND, TN 38002 P. 901.372.0404 WWW.A2H.COM



COMMISSION BUILDING RENOVATION

BROWNSVILLE, TN

100% CONSTRUCTION DOCUMENTS

REVISIONS

PROJECT NO.	DATE
24262	AUGUST 14, 2024
DRAWN	CHECKED

ELECTRICAL LEGEND AND

ABBREVIATIONS N.T.S.

N.T.S.

GENERAL NOTES

N.T.S.

ELECTRICAL LEGEND

3. DEMOLISH MEANS DISCONNECT, REMOVE FROM SITE AND DISPOSE OF IN A LEGAL MANNER. 5. WHERE DEVICES ARE INDICATED TO BE DEMOLISHED, INCLUDE ELECTRICAL DEVICES, ACCESSIBLE RACEWAYS, WIRING, AND ACCESSIBLE BOXES. ARCHITECTURAL AND DEMOLITION DRAWINGS TO EXISTING CONDITIONS. UNUSED CONDUITS.

— PRESERVE FOR RELOCATION

ELECTRICAL DEMOLITION PLAN

1/4" = 1'-0"

ELECTRICAL DEMOLITION NOTES

- 1. PRESERVE EXISTING ELECTRICAL SYSTEMS IN THEIR ENTIRETY UNLESS OTHERWISE
 - A. DEMOLISH DASHED DEVICES AND EQUIPMENT
 - 2. COORDINATE ANY INTERUPTION OF THE ELECTRIC OR COMMUNICATIONS SERVICES WITH OWNER'S REPRESENTATIVE (2) WEEKS PRIOR INTERRUPTION DATE.
 - 4. DEMOLISH ELECTRICAL DEVICES, EQUIPMENT AND MATERIALS INDICATED BY HATCHING OR
 - NOTE, UNLESS OTHERWISE INDICATED.
 - 6. PERFORM DEMOLITION OF EQUIPMENT AND MATERIALS THAT MAY BE REQUIRED OR NECESSARY FOR THE FULL AND COMPLETE EXECUTION OF THE WORK, WHETHER EXPLICITLY SHOWN AND/OR SPECIFIED OR NOT. EXACT EXTENT OF DEMOLITION WILL NOT BE FULLY INDICATED BY DRAWINGS. DETERMINE THE NATURE AND EXTENT OF DEMOLITION THAT WILL BE NECESSARY BY COMPARING THE CONTRACT DOCUMENTS WITH
 - 7. RETURN EXISTING ELECTRICAL EQUIPMENT WHICH WILL NOT BE REUSED TO THE OWNER OR REMOVE FROM THE PREMISES AS DETERMINED BY THE PROJECT MANAGER.
- 8. DEMOLISH OR RELOCATE ANY EXISTING ELECTRICAL MATERIAL AND EQUIPMENT WHICH INTERFERES WITH THE NEW ADDITION OR THE REMOVAL OF EXISTING WALLS AS DETERMINED BY THE PROJECT MANAGER.
- 9. WHERE DEMOLITION OCCURS AND CIRCUITS CONTINUE, PROVIDE CONDUCTORS TO CONNECT FROM POINT OF ORIGIN OR LAST USE TO POINT OF CONTINUATION. WHERE CIRCUITS DO NOT CONTINUE REMOVE CONDUCTORS TO POINT OF ORIGIN OR LAST POINT OF USE TO KEEP ANY ITEMS THAT REMAIN IN OPERATION AS UNUSED CONDUITS. CAP

GENERAL NOTES - DEMOLITION

A2H, INC.

3009 DAVIES PLANTATION ROAD

LAKELAND, TN 38002

P. 901.372.0404

WWW.A2H.COM

ELECTION COMMISSION BUILDING RENOVATION

BROWNSVILLE, TN

100% CONSTRUCTION **DOCUMENTS**

REVISIONS

CHECKED

ELECTRICAL -DEMOLITION - FLOOR PLAN

INTERIOR LUMINAIRE SCHEDULE MANUFACTURER COLOR DIMMING WATTS MOUNTING REMARKS DESCRIPTION MODEL LUMENS SLIM PROFILE LINEAR VODE LIGHTING 807 NX3 SL 31 60 SM 0 RP50 AE 1 0 Z LO 35 CE 0 AL 0 3500K CCT LOW OUTPUT 0-10V 10% CEILING/SURFACE MOUNT LITHONIA LDN4 35/20 LO4AR LSS MVOLT GZ10 3500K CCT 0-10V 10% 30 VA RECESSED 4INCH RECESSED DOWNLIGHT EMERGENCY LIGHTING UNIT LITHONIA NONE 4 VA WALL MOUNT 7FT AFF ELM4L ECC G NONE X EXIT SIGN WITH TWIN HEAD LITHONIA 2 VA CEILING MOUNT N/A

SUBMITTALS AND SUBSTITUTIONS:

- 1. MANUFACTURER'S TRADE NAMES OR CATALOG NUMBERS USED IN THIS SCHEDULE ARE A BASIS OF DESIGN TO DENOTE TYPE, SIZE, QUALITY, AND DESIGN OF EQUIPMENT REQUIRED. SEE SPECIFICATIONS FOR LIST OF PRE-APPROVED ALTERNATE MANUFACTURERS AND AGENCIES.
- 2. SUBMIT DATA SHEETS AND SHOP DRAWINGS FROM MANUFACTURER TO VERIFY SELECTIONS AND CONNECTIONS. SUBMITTAL DATA SHEETS SHALL BE ON LETTERHEAD OF AGENCY REPRESENTING MANUFACTURERS IN THE TERRITORY WHERE THE PROJECT IS LOCATED.
- 3. WHERE A SUBSITUTE LIGHTING PACKAGE IS SUBMITTED FOR ENGINEER REVIEW, PROVIDE ALL FIXTURE CUTSHEETS WITH OPTIONS CLEARLY INDICATED. PROVIDE AN ELECTRONIC COPY OF PHOTOMETRIC CALCULATIONS FOR EACH SPACE WITH VISUAL LIGHTING SOFTWARE.
- 4. FURNISH SPECIFIED MATERIALS WHERE SUBSTITUTIONS ARE NOT APPROVED.

A1 LU

LUMINAIRE SCHEDULE

GENERAL NOTES

- 1. SEE SHEET E0.0.
- 2. PROVIDE LIGHTING AND LIGHTING CONTROLS.
- POWER PACK TO CONTROL VOTING ROOM. OCCUPANCY SENSORS ON 20 MINUTE TIMEOUT. LOCAL ON/OFF/DIMMING SWITCH



AZH, INC.
3009 DAVIES PLANTATION ROAD
LAKELAND, TN 38002
P. 901.372.0404
WWW.A2H.COM



GENERAL NOTES

HAYWOOD COUNTY

ELECTION
COMMISSION
BUILDING
RENOVATION

BROWNSVILLE, TN


100% CONSTRUCTION DOCUMENTS

REVISIONS

PROJECT NO.	DATE
24262	AUGUST 14, 2024
DRAWN	CHECKED

LIGHTING - FIRST FLOOR Plan

E1.1

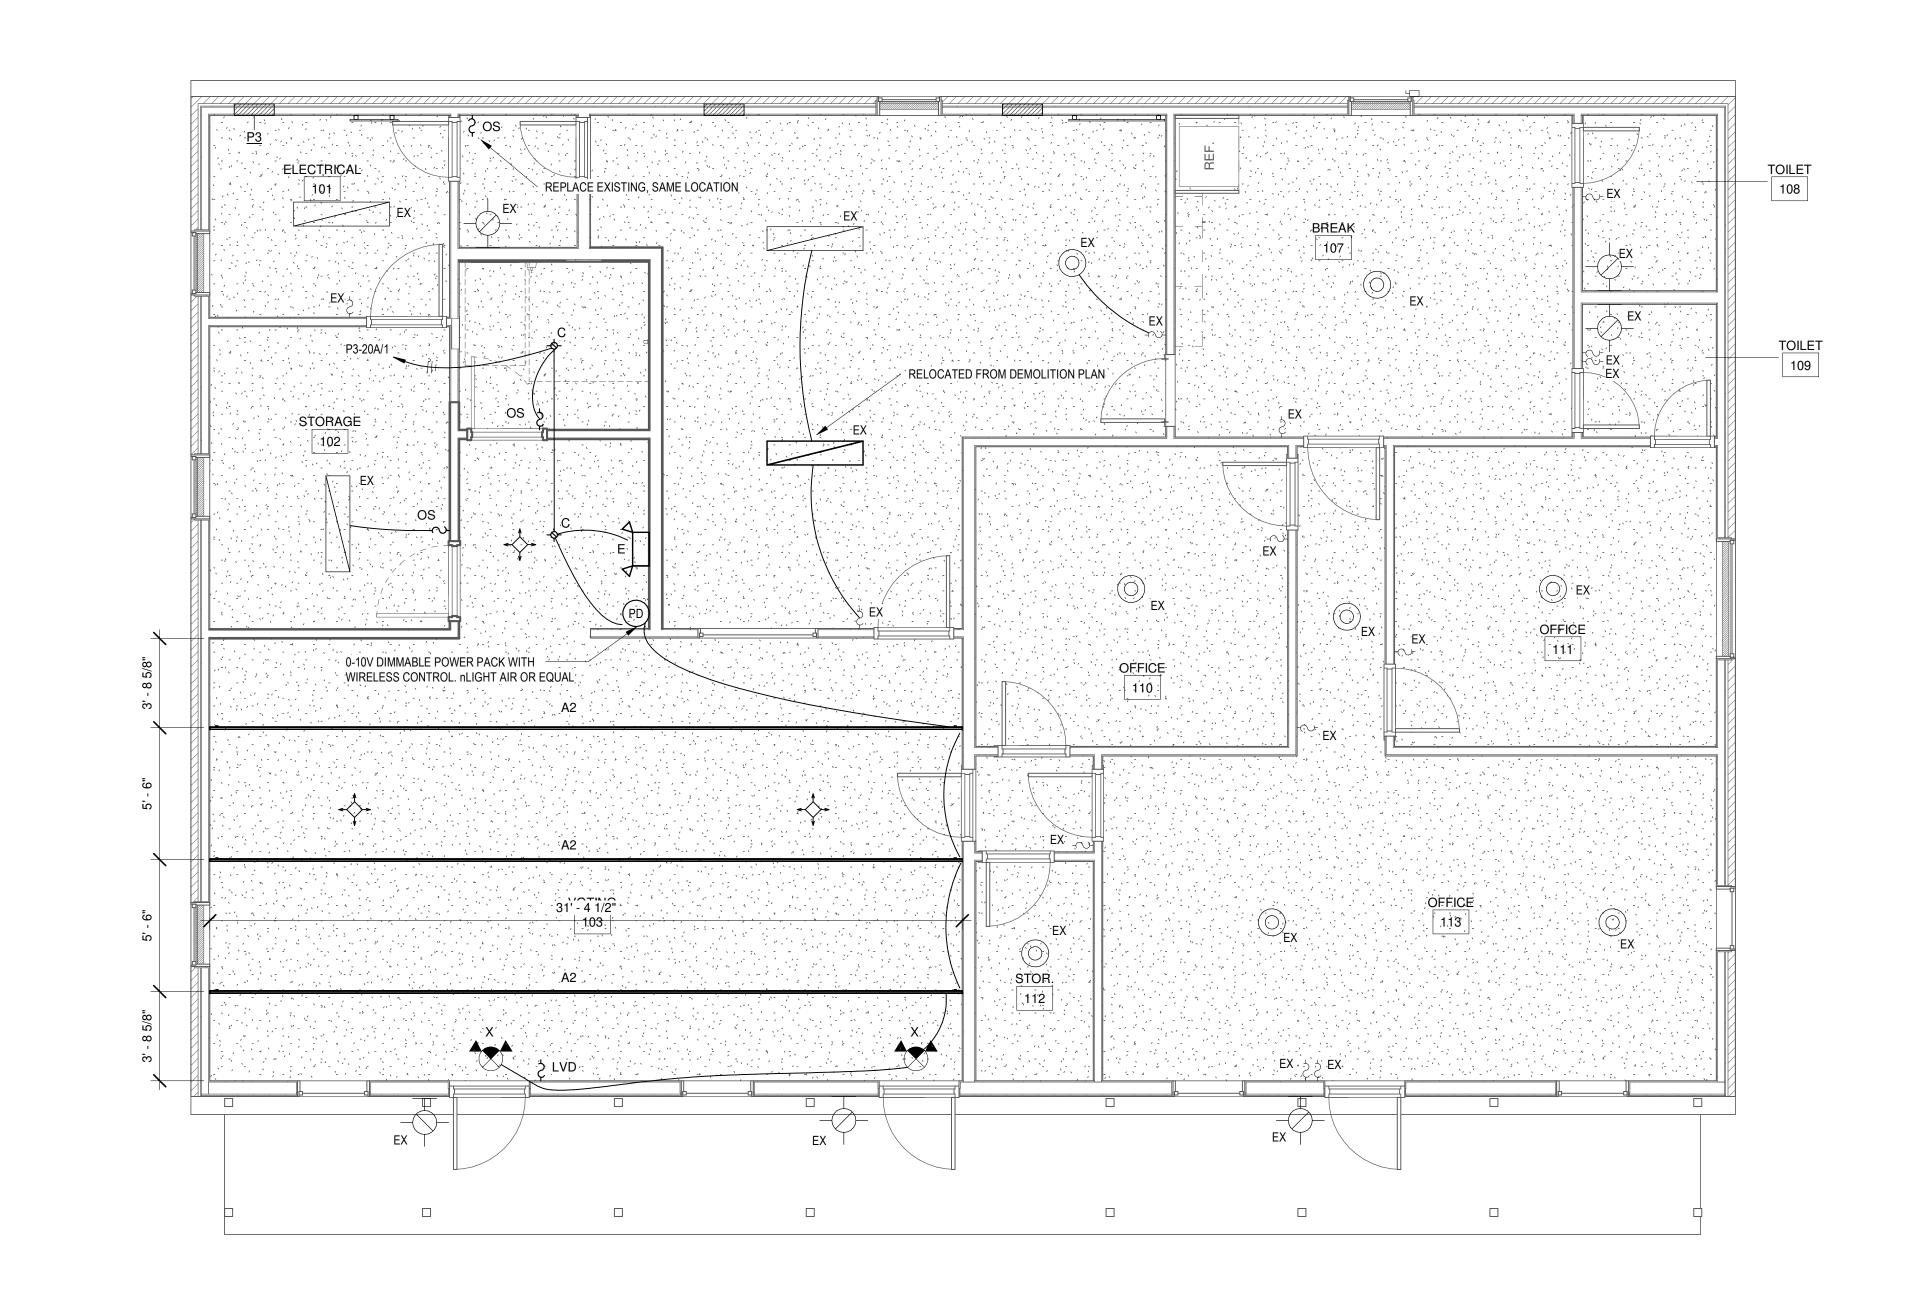

D1 1/4" = 1'-0" LIGHTING PLAN



GENERAL NOTES

- 1. SEE SHEET E0.0.
- 2. PRESERVE EXISTING ELECTRICAL DISTRIBUTION.

KEYED NOTES (#)

- 1. CONNECT TO LIGHT SWITCH SERVING SPACE
- 4 GANG FLOORBOX WITH WHILE IN USE COVER. GREY FINISH
 A. 2) DUPLEX RECEPTACLES
 B. (2) GANGS RESERVED FOR DATA
 C. 1"C TO ELECTRICAL ROOM FOR DATA CABLING

A2H, INC. 3009 Davies Plantation Road P. 901.372.0404 WWW.A2H.COM

GENERAL AND KEYED NOTES N.T.S.

HAYWOOD COUNTY

ELECTION COMMISSION BUILDING RENOVATION

BROWNSVILLE, TN


100% CONSTRUCTION **DOCUMENTS**

REVISIONS

PROJECT NO.	DATE
24262	AUGUST 14, 2024
DRAWN	CHECKED

POWER - FIRST FLOOR Plan

E2.1

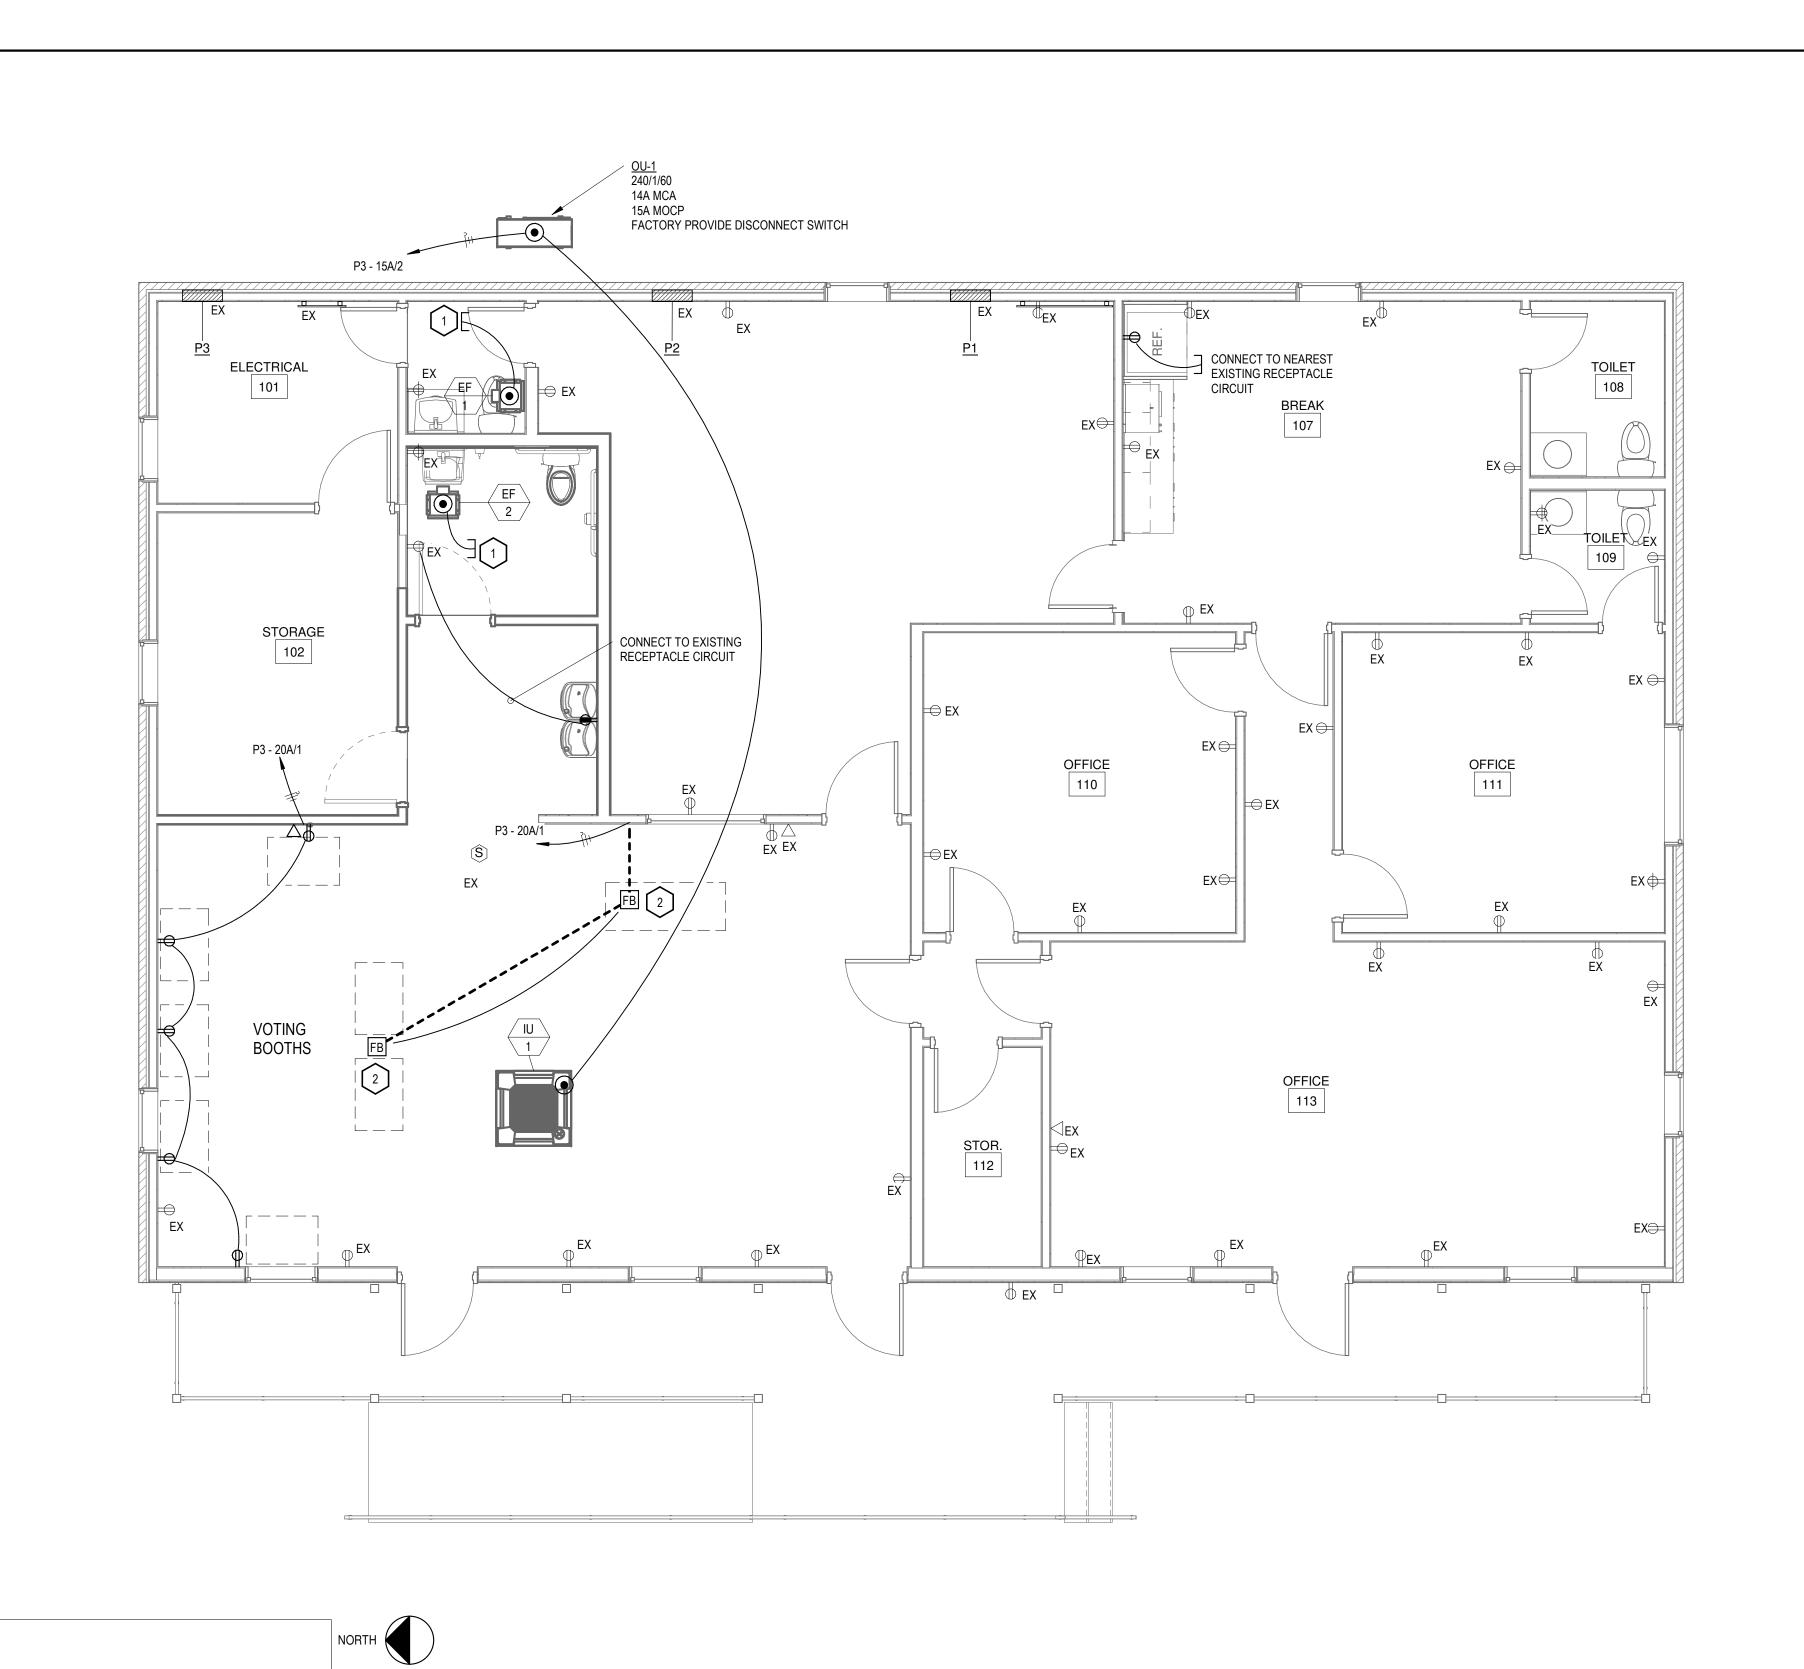

D11/4" = 1'-0"

POWER PLAN



A2H, INC. 3009 DAVIES PLANTATION ROAD LAKELAND, TN 38002 P. 901.372.0404 WWW.A2H.COM



AYWOOD COUNTY

ELECTION
COMMISSION
BUILDING
RENOVATION

BROWNSVILLE, TN

100% CONSTRUCTION DOCUMENTS

REVISIONS

PROJECT NO.
24262 DRAWN CHECKED

ELECTRICAL SPECIFICATIONS

F7 0